

ZZZ63 681H AVE S KENT, WA 98032

MARCH 1, 2021

City of Seattle Department of Neighborhoods

Attn: Genna Nashem

Pioneer Square Preservation District

PO Box 94649, Seattle, WA 98124-4649

Re: AT&T/MASTEC - 15586-023-E

To Genna and the Pioneer Square Preservation Board:

Mastec Network Solution will be providing replaced Colocation Street light with a SWF, for the above referenced Project under MASTEC - 15586-023-E. This work is in review with Seattle Department of Transportation (SDOT) under Permit #421117 - 515 2ND AVE. This is a key network area for AT&T and they need a site as close to the intersection of Yesler Way & 2nd Ave as possible. There are no other wood poles in the vicinity, so AT&T is requesting to replace this streetlight in order to meet service demand needs. The Site Plans and the PSPB Doc are attached for review and reference.

Our project proposes to: Permit the install of a SWF, and bring to standards the SCL infrastructure, proposed Under SCL Work Order #1915166. From the existing SCL Vault (126-m-1) on the NE corner of Yester way and James Street, Trench and Install (2) 3" conduits East to a Proposed Street Light Distribution Hand Hole (Proposed Hand Hole to replace Existing Hand Hole as per SDOT and SCL Standards, including Pedestrian Mobility) Pull Conductors through existing and Newly Place RGS conduit west. All New RGS will be installed in existing hangers and installed as per SCL Standards. Install new Co-Location Street Light and Foundation, with SWF on newly installed Pole. Pole and Foundation designed By Lets America to Meet or Exceed SDOT and SCL Standards. SCL inspectors will be on site to ensure standards are met.

Mastec Network Solutions will coordinate restoration with



22263 68TH AVE S KENT, WA 98032

SDOT Inspectors, to ensure Standards are met. Mastec contractor will restore sidewalk per SDOT standards (SDOT Standard 420. See sheet 22 and 23 of Plan Set for reference). 3/8" through and contraction joints shall be located as required by Section 8-14.3(6). "V" groove scoring and gray dye added to match pattern of adjacent existing sidewalk or shall be a 2' square scoring pattern. The contractor will also work to protect existing American Disabilities Act (ADA) ramps in place (See sheets 24-27 of Plan Set for reference).

Please let us know if anything in addition is required to proceed with the review.

Thank you,

Jay Rodriguez
Project Manager
Mastec Network Solutions

Attachments:

- Drawings Permit #421117
- PSPB Reverence Doc

SIMULATION PHOTOGRAPH

PROPOSED VEIW FACING SE ON WEST SIDE OF 2ND AVE

PROPOSED VEIW FACING SE ON WEST SIDE OF 2ND AVE





NOTES:

- CONTRACTOR TO COORDINATE WITH SDOT YARD FOR STORAGE OF EXISTING BRONZE BASE. TO BE RE-INSTALLED ON NEW POLE.
 NEW EQUIPMENT TO BE PAINTED
- COATING, DGS2-40003, RAILROAD GREEN. RF TRANSPARENT AND UV RESISTANT OUTDOOR RATED



	M			
NO.	DATE	ENGINEER	DRAFTER	COMMENT
1	8/28/20	MF	DDS	ORIGINAL
2	2/17/21	KW	KAW	REVISION # 3
3				AS-BUILT





CLIENT PROJECT MANAGER: GIN VILANTE ENGINEERING FIRM: MGC TECHNICAL CONSULTING INC.

PROJECT NUMBER: 15586-023-E LOCATION: 515 2ND AVE SEATTLE, WA 98104

CONFIDENTIAL/PROPRIETARY

DRAWING NAME: MASTEC - 15586-023-E - PSPB.dwg

SHEET: 1 OF 18


SIMULATION PHOTOGRAPH

PROPOSED VEIW FACING NW ON WEST SIDE OF 2ND AVE

PROPOSED VEIW FACING NW ON WEST SIDE OF 2ND AVE

NOTES:

- CONTRACTOR TO COORDINATE WITH SDOT YARD FOR STORAGE OF EXISTING BRONZE BASE. TO BE RE-INSTALLED ON NEW POLE.
- COATING, DGS2-40003, RAILROAD GREEN. RF TRANSPARENT AND UV RESISTANT OUTDOOR RATED

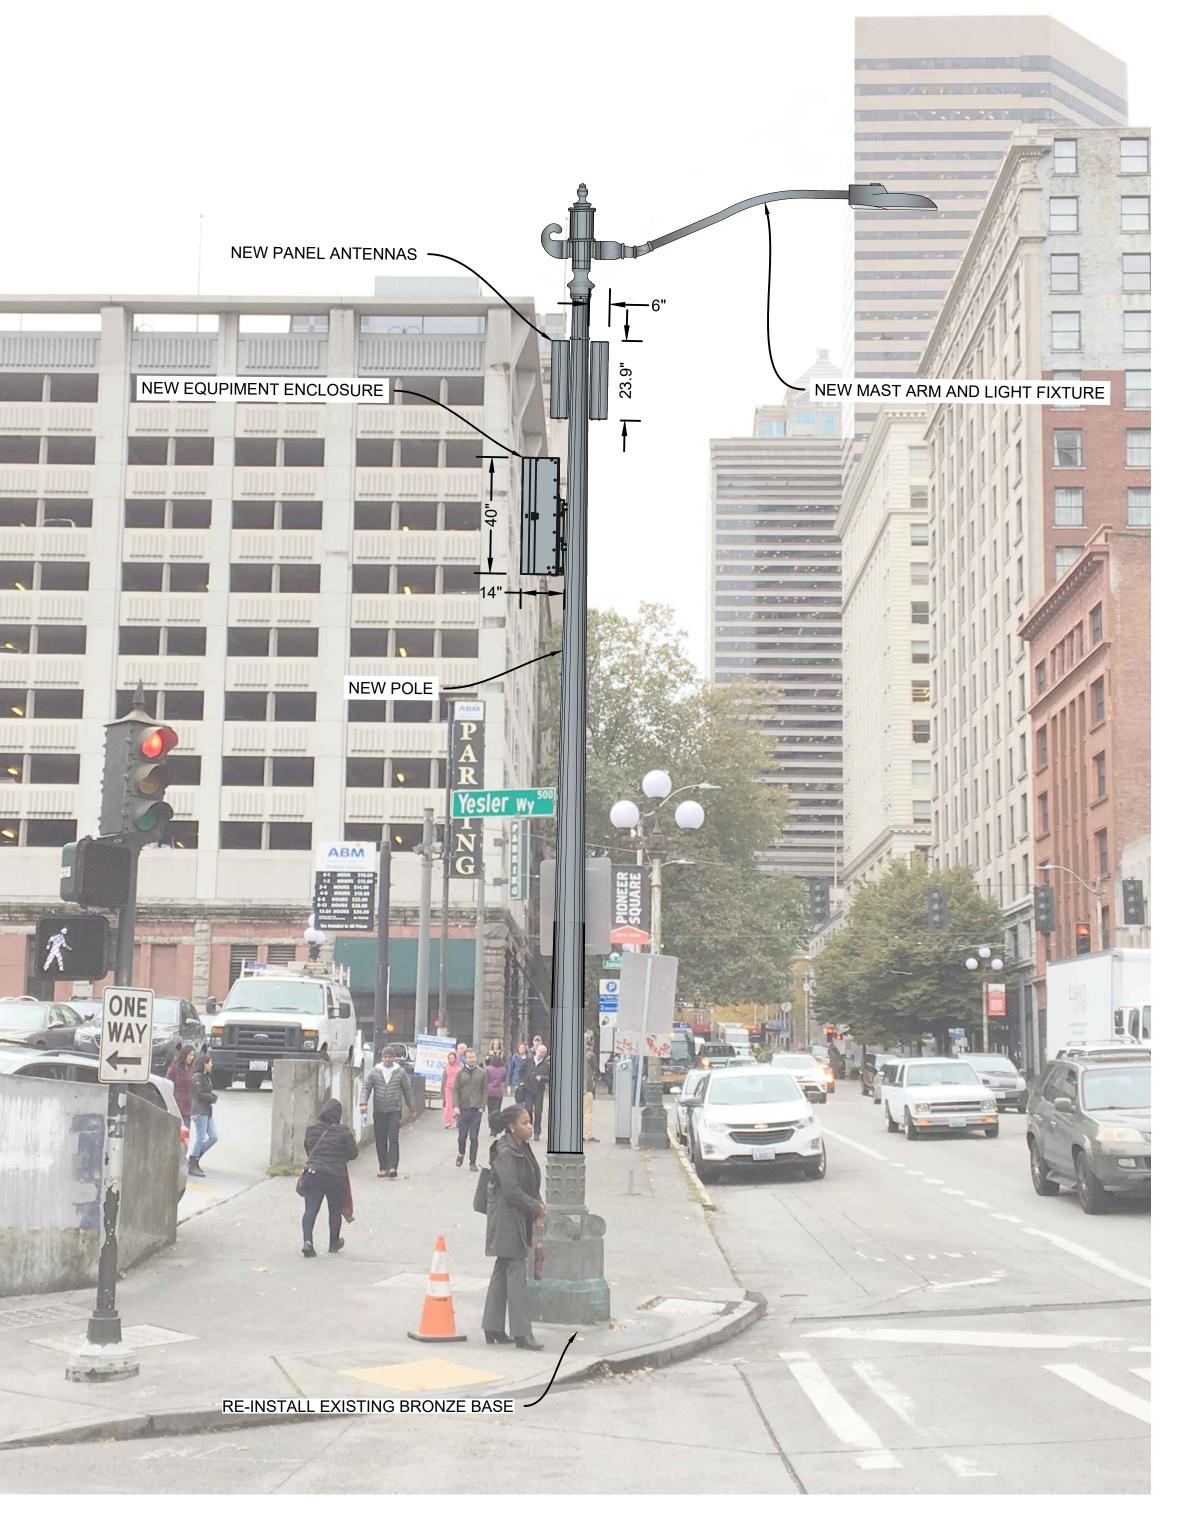



NO.	DATE	ENGINEER	DRAFTER	COMMENT
1	8/28/20	MF	DDS	ORIGINAL
2	2/17/21	KW	KAW	REVISION # 3
3				AS-BUILT





CLIENT PROJECT MANAGER: GIN VILANTE

ENGINEERING FIRM: MGC TECHNICAL CONSULTING INC.

PROJECT NUMBER: 15586-023-E LOCATION: 515 2ND AVE

SEATTLE, WA 98104

DRAWING NAME: MASTEC - 15586-023-E - PSPB.dwg


CONFIDENTIAL/PROPRIETARY

SHEET: 2 OF 18

COVERAGE MAP


NOTES:

SDOT CITY LIGHT POLE #1313162. PROPOSED ARE OF COVERAGE HIGHLIGHTED IN GREEN.

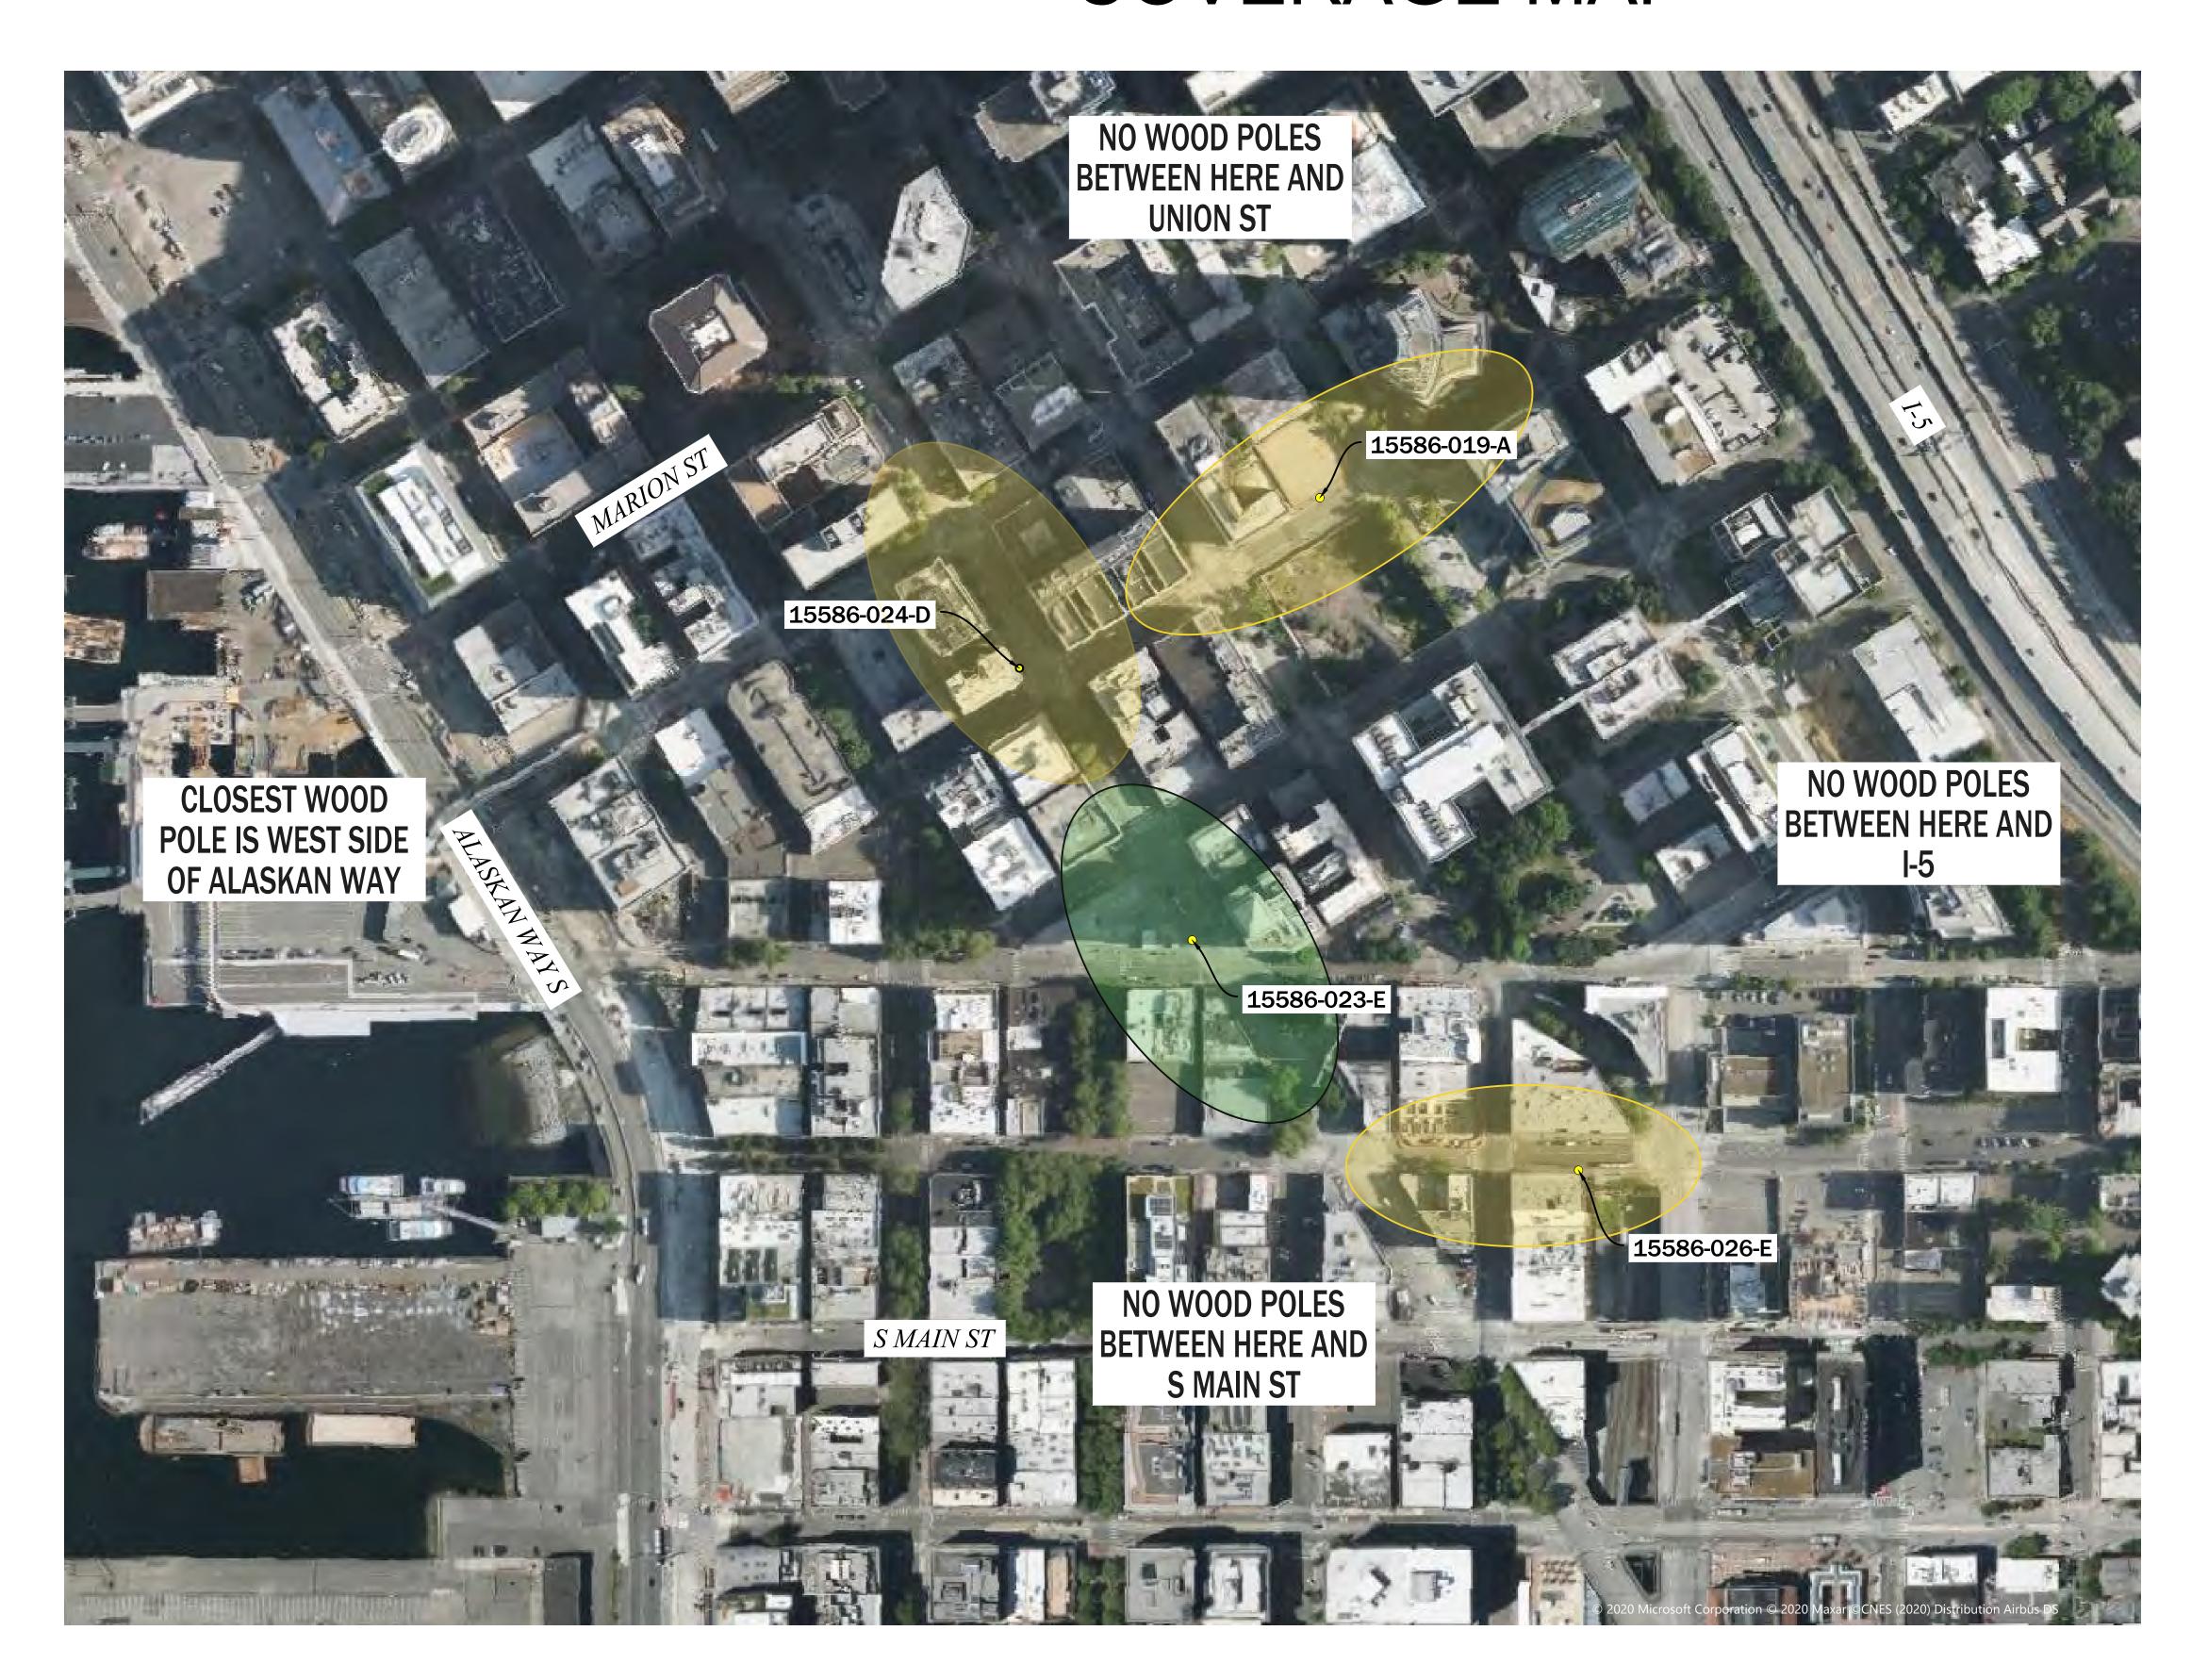

AS-BUILT 2 2/17/21 KW KAW REVISION # 3 1 8/28/20 MF DDS ORIGINAL NO. DATE ENGINEER DRAFTER COMMENT ***********************************										
1 8/28/20 MF DDS ORIGINAL NO. DATE ENGINEER DRAFTER COMMENT ***MASTEC C Network Solutions CLIENT PROJECT MANAGER: GIN VILANTE ENGINEERING FIRM: MGC TECHNICAL CONSULTING INC. PROJECT NUMBER: 15586-023-E LOCATION: 515 2ND AVE SEATTLE, WA 98104 DRAWING NAME: MASTEC - 15586-023-E - PSPB.dwg	3				AS-BUILT					
NO. DATE ENGINEER DRAFTER COMMENT **Mastec Comm	2	2/17/21	KW	KAW	REVISION # 3					
**Mastec - 15586-023-E - PSPB.dwg	1	8/28/20	MF	DDS	ORIGINAL					
Network Solutions CLIENT PROJECT MANAGER: GIN VILANTE ENGINEERING FIRM: MGC TECHNICAL CONSULTING INC. PROJECT NUMBER: 15586-023-E LOCATION: 515 2ND AVE SEATTLE, WA 98104 DRAWING NAME: MASTEC - 15586-023-E - PSPB.dwg	NO.	DATE	ENGINEER	DRAFTER	COMMENT					
ENGINEERING FIRM: MGC TECHNICAL CONSULTING INC. PROJECT NUMBER: 15586-023-E LOCATION: 515 2ND AVE SEATTLE, WA 98104 DRAWING NAME: MASTEC - 15586-023-E - PSPB.dwg	•				MGE TECHNICAL CONSULTING INC					
PROJECT NUMBER: 15586-023-E LOCATION: 515 2ND AVE SEATTLE, WA 98104 DRAWING NAME: MASTEC - 15586-023-E - PSPB.dwg	CLI	ENT PROJE	CT MANAGE	R: GIN VILA	NTE					
LOCATION: 515 2ND AVE SEATTLE, WA 98104 DRAWING NAME: MASTEC - 15586-023-E - PSPB.dwg	ENG	GINEERING	FIRM: MGC	TECHNICAL	CONSULTING INC.					
SEATTLE, WA 98104 DRAWING NAME: MASTEC - 15586-023-E - PSPB.dwg	PRO	OJECT NUM	BER: 15586	-023-E						
	LOC									
CONFIDENTIAL/PROPRIETARY SHEET: 3 OF 18	DRA	AWING NAM	E: MASTEC -	15586-023-E - F	PSPB.dwg					
	COI	NFIDENTIAL	/PROPRIET/	ARY	SHEET: 3 OF 18					

SITE PHOTO 1: FACING NE IN THE MIDDLE OF YESLER WAY

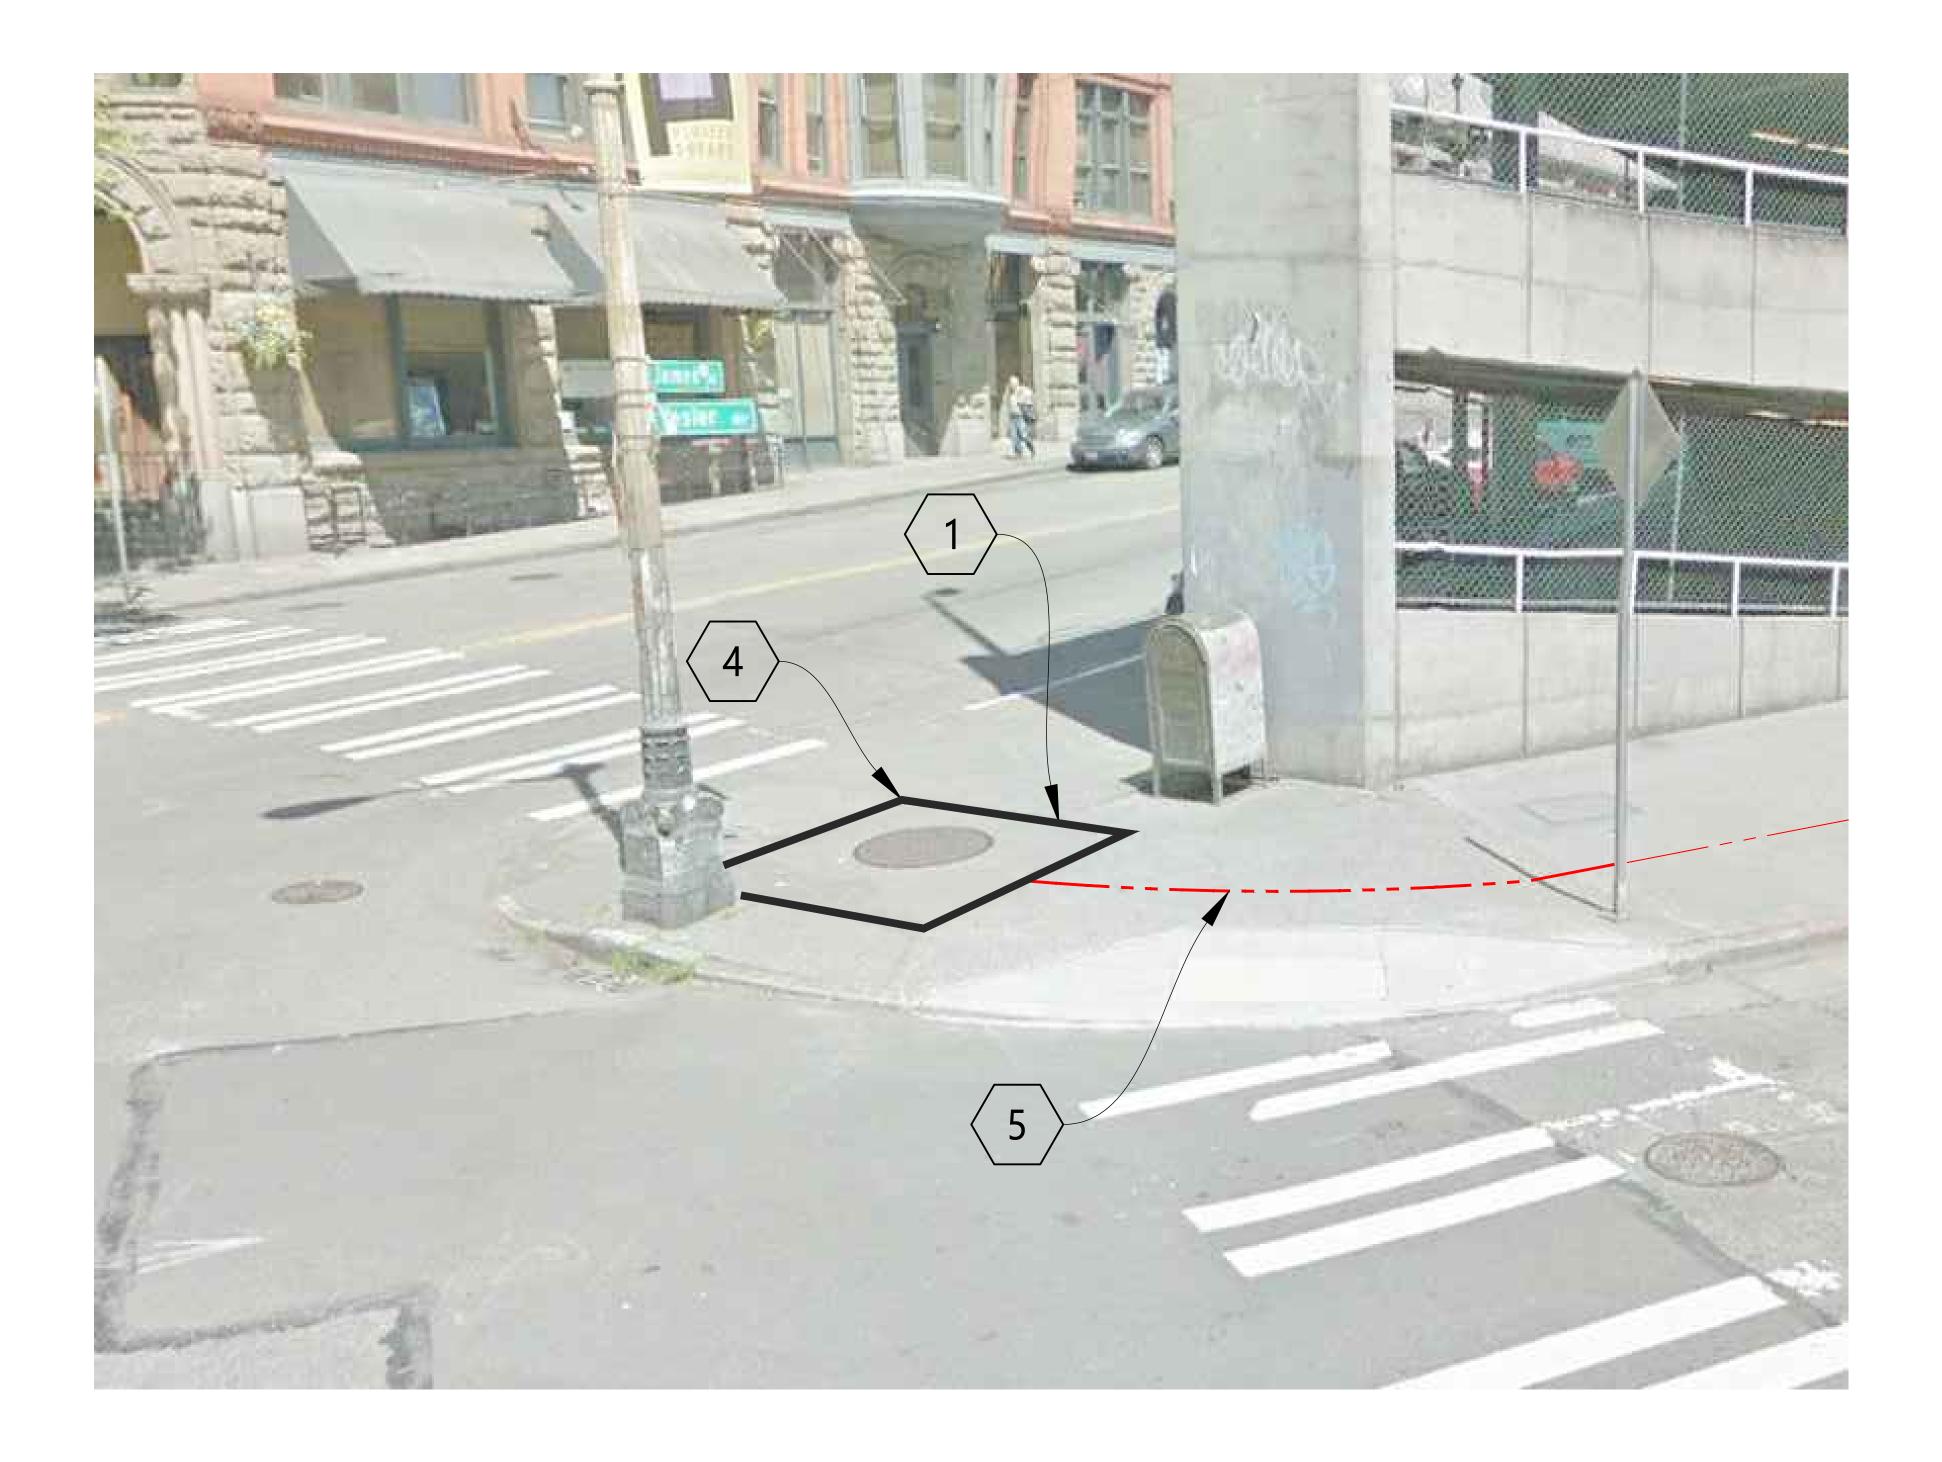

CONSTRUCTION NOTES

- 1 COORDINATE WITH STREETLIGHT CREW FOR SERVICE DISCONNECTION FROM MH 126-M-1 TO ASSET#1313162.
- EXISTING SCL VAULT 126-M-1, CONTRACTOR TO CORE VAULT AND INSTALL CONDUIT PER SCL CONSTRUCTION STANDARD 7020.05.
- 5 CONTRACTOR TO TRENCH AND REMOVE EXISTING CONDUIT. INSTALL (2) 3" RGS CONDUIT FROM MH 126-M-1 TO 126-H-2. INSTALL PER SCL CONSTRUCTION STANDARD 0095.60 AND 1716.07.



				•
NO.	DATE	ENGINEER	DRAFTER	COMMENT
1	8/28/20	MF	DDS	ORIGINAL
2	2/17/21	KW	KAW	REVISION # 3
3				AS-BUILT





CLIENT PROJECT MANAGER: GIN VILANTE ENGINEERING FIRM: MGC TECHNICAL CONSULTING INC.

PROJECT NUMBER: 15586-023-E


LOCATION: 515 2ND AVE SEATTLE, WA 98104

DRAWING NAME: MASTEC - 15586-023-E - PSPB.dwg

CONFIDENTIAL/PROPRIETARY

SHEET: 4 OF 18

SITE PHOTO 2: FACING EAST ON NORTH SIDE OF YESSLER WAY

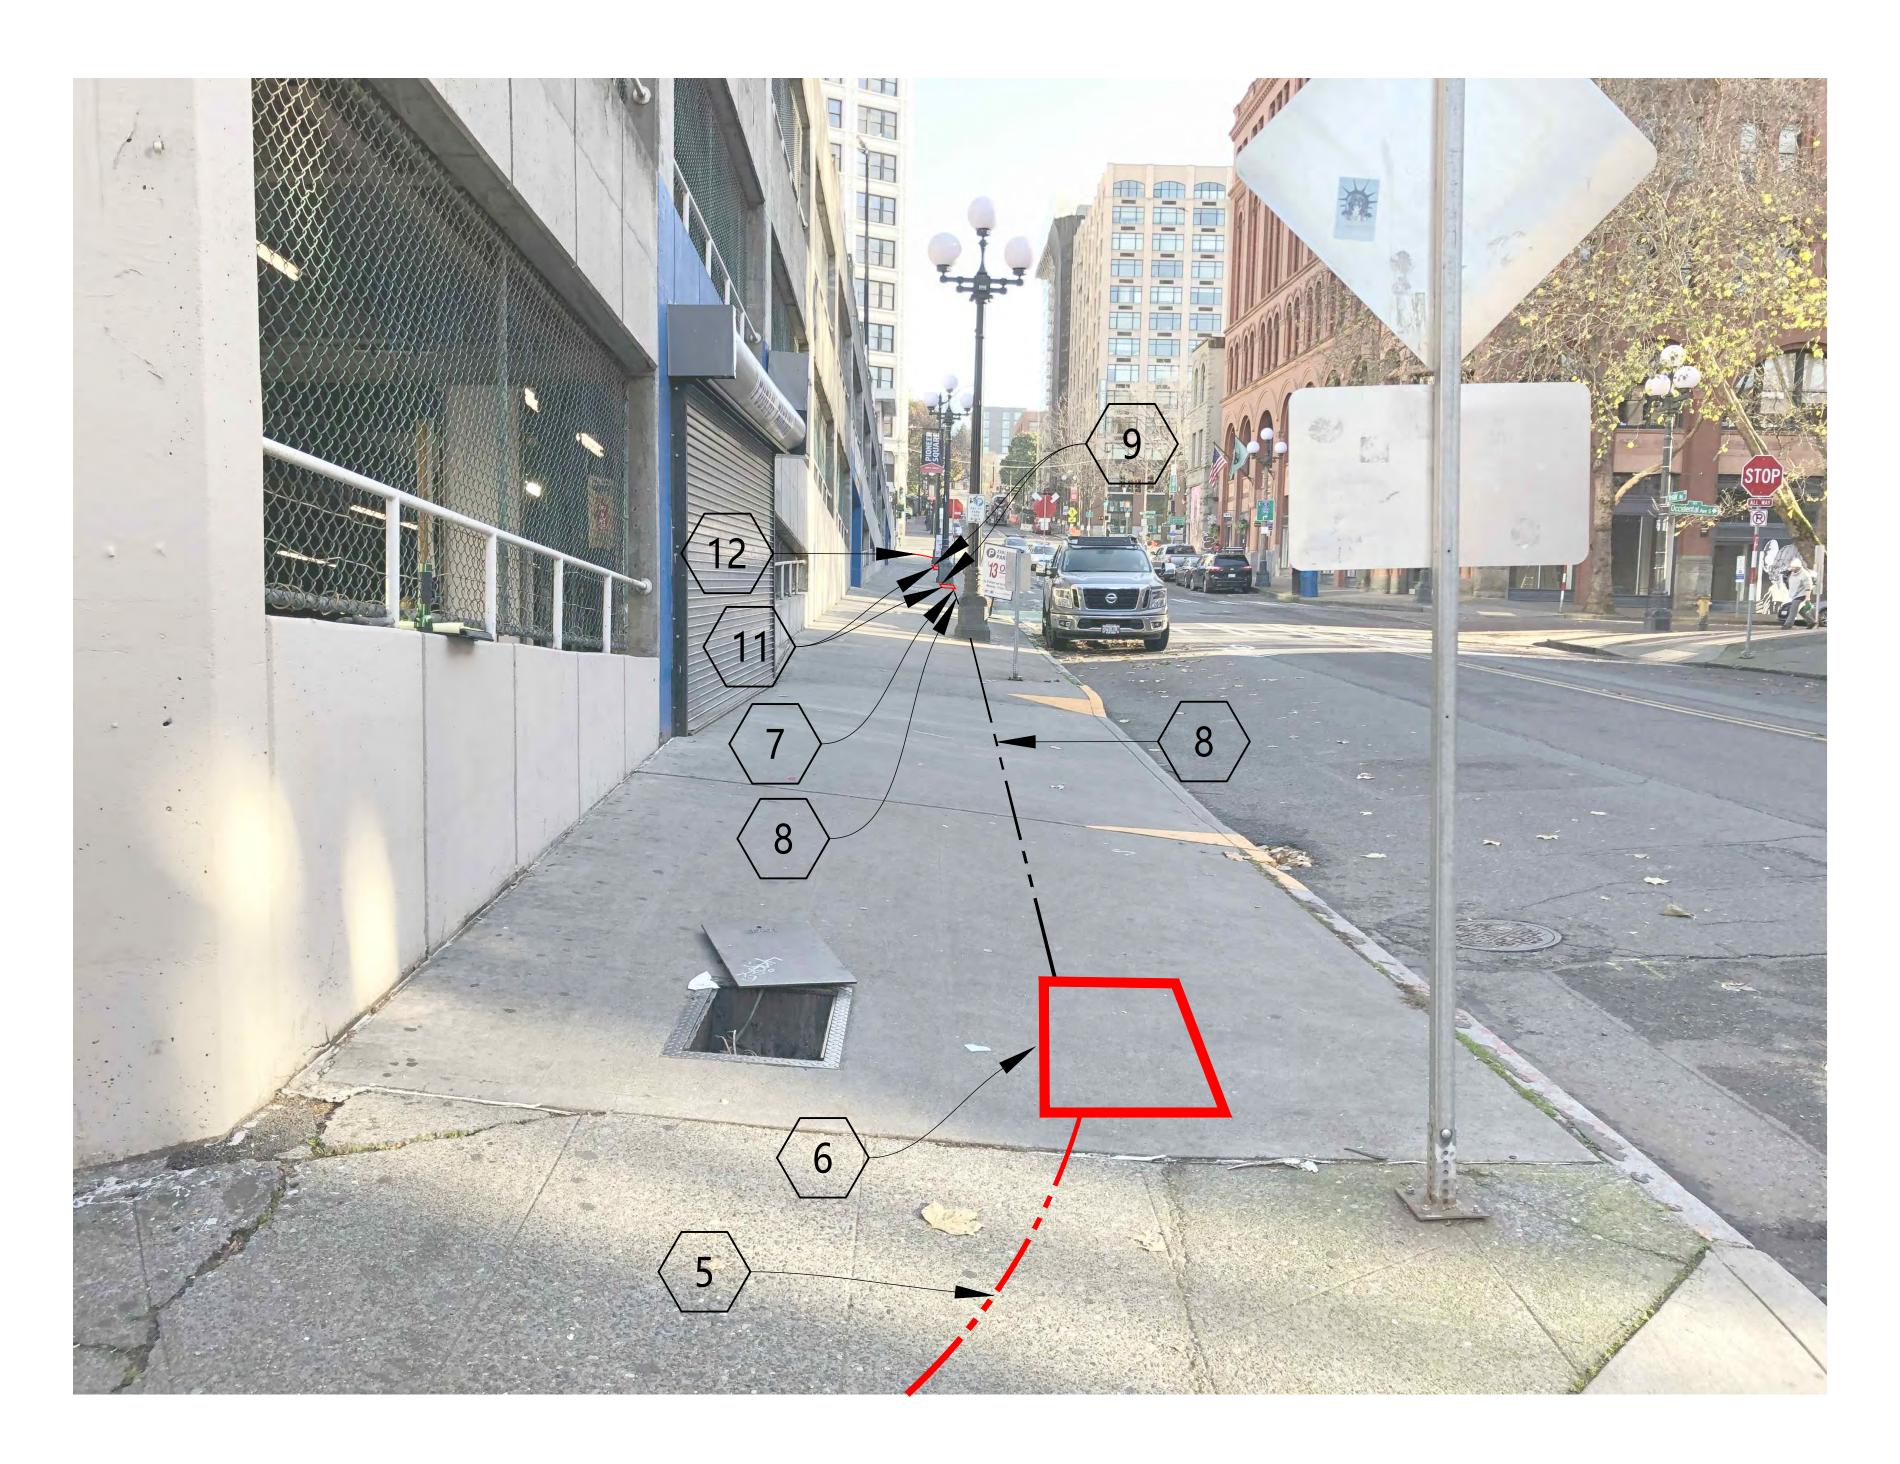

CONSTRUCTION NOTES

- 5 CONTRACTOR TO TRENCH AND REMOVE EXISTING TO 126-H-2. INSTALL PER SCL CONSTRUCTION STANDARD 0095.60 AND 1716.07.
- 6 CONTRACTOR TO REPLACE HH 126-H-2 WITH (1) NEW TYPE-5 SL HH PER COS STD PLAN 550A AND SCL CONSTRUCTION STANDARD 1716.07.
- 7 CONTRACTOR TO INSTALL (1) 3-1/2" RGS CONDUIT FROM EXISTING 3-1/2" RGS TO J-BOX-2. INSTALL PER SCL CONSTRUCTION STANDARDS 0095.60 AND 1716.07.
- 8 PULL THROUGH EXISTING (1) 3-1/2" RGS CONDUIT. FROM NEWLY INSTALLED TYP5 5 HH TO NEWLY INSTALLED 3-1/2"
- 9 CONTRACTOR TO RE-ROUTE EXISTING CONDUIT FROM POLE BASE TO NEWLY-INSTALLED HH.
- (11) CONTRACTOR TO INSTALL (1) NEW NEMA 4X STAINLESS STEEL J-BOX SIMILAR IN SIZE TO TYPE-2 HH. INTERCEPT EXISTING CONDUIT. MOUNTING OF J-BOX TO BE APPROVED BY STRUCTURAL ENGINEER AND SDOT IN AREA WAY.
- (12) CONTRACTOR TO INSTALL (2) 2" RGS CONDUIT FROM J-BOX-3 TO J-BOX-4. INSTALL PER SCL CONSTRUCTION STANDARD 0095.60 AND 1716.07.



SEE SHEET 4 OF SCHEMATIC VIEW.

3				AS-BUILT
2	2/17/21	KW	KAW	REVISION # 3
1	8/28/20	MF	DDS	ORIGINAL
NO.	DATE	ENGINEER	DRAFTER	COMMENT





CLIENT PROJECT MANAGER: GIN VILANTE ENGINEERING FIRM: MGC TECHNICAL CONSULTING INC.

PROJECT NUMBER: 15586-023-E LOCATION: 515 2ND AVE

SEATTLE, WA 98104 DRAWING NAME: MASTEC - 15586-023-E - PSPB.dwg

CONFIDENTIAL/PROPRIETARY

SHEET: 5 OF 18

SITE PHOTO 3: FACING WEST IN AREAWAY

CONSTRUCTION NOTES

- CONTRACTOR TO INSTALL (1) 3-1/2" RGS CONDUIT FROM EXISTING 3-1/2" RGS TO J-BOX-2. INSTALL PER SCL CONSTRUCTION STANDARDS 0095.60 AND 1716.07.
- 8 PULL THROUGH EXISTING (1) 3-1/2" RGS CONDUIT. FROM NEWLY INSTALLED TYP5 5 HH TO NEWLY INSTALLED 3-1/2"





NO.	DATE	ENGINEER	DRAFTER	COMMENT
1	8/28/20	MF	DDS	ORIGINAL
2	2/17/21	KW	KAW	REVISION # 3
3				AS-BUILT





CLIENT PROJECT MANAGER: GIN VILANTE ENGINEERING FIRM: MGC TECHNICAL CONSULTING INC.

PROJECT NUMBER: 15586-023-E LOCATION: 515 2ND AVE


SEATTLE, WA 98104 DRAWING NAME: MASTEC - 15586-023-E - PSPB.dwg

CONFIDENTIAL/PROPRIETARY

SHEET: 6 OF 18


SITE PHOTO 4: FACING EAST IN AREAWAY



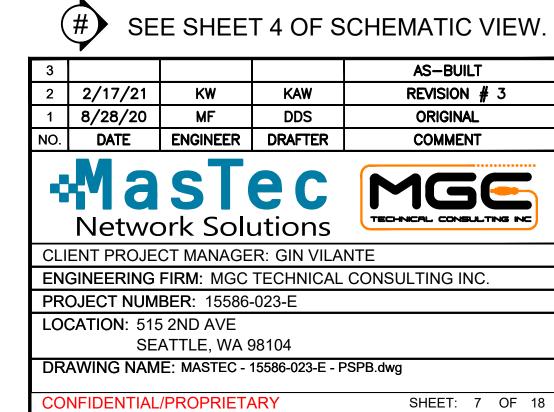

SITE PHOTO 5: FACING WEST IN AREAWAY



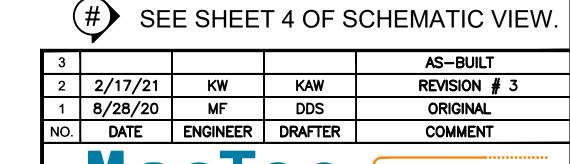



LOCATION: 515 2ND AVE
SEATTLE, WA 98104
DRAWING NAME: MASTEC - 15586-023-E - PSPB.dwg

CONFIDENTIAL/PROPRIETARY SHEET

SHEET: 8 OF 18

SITE PHOTO 6: FACING EAST IN AREAWAY






3				AS-BUILT				
2	2/17/21	KW	KAW	REVISION # 3				
1	8/28/20	MF	DDS	ORIGINAL				
NO.	DATE	ENGINEER	DRAFTER	COMMENT				
	**MasTec Network Solutions **MasTec **Mastec							
CLI	CLIENT PROJECT MANAGER: GIN VILANTE							
ENG	ENGINEERING FIRM: MGC TECHNICAL CONSULTING INC.							
PRO	DJECT NUM	BER: 15586-	-023-E					
LOC	CATION: 515	2ND AVE						
	SE	ATTLE. WA 9	98104					

SHEET: 9 OF 18

DRAWING NAME: MASTEC - 15586-023-E - PSPB.dwg

CONFIDENTIAL/PROPRIETARY

SITE PHOTO 7: FACING EAST IN AREAWAY

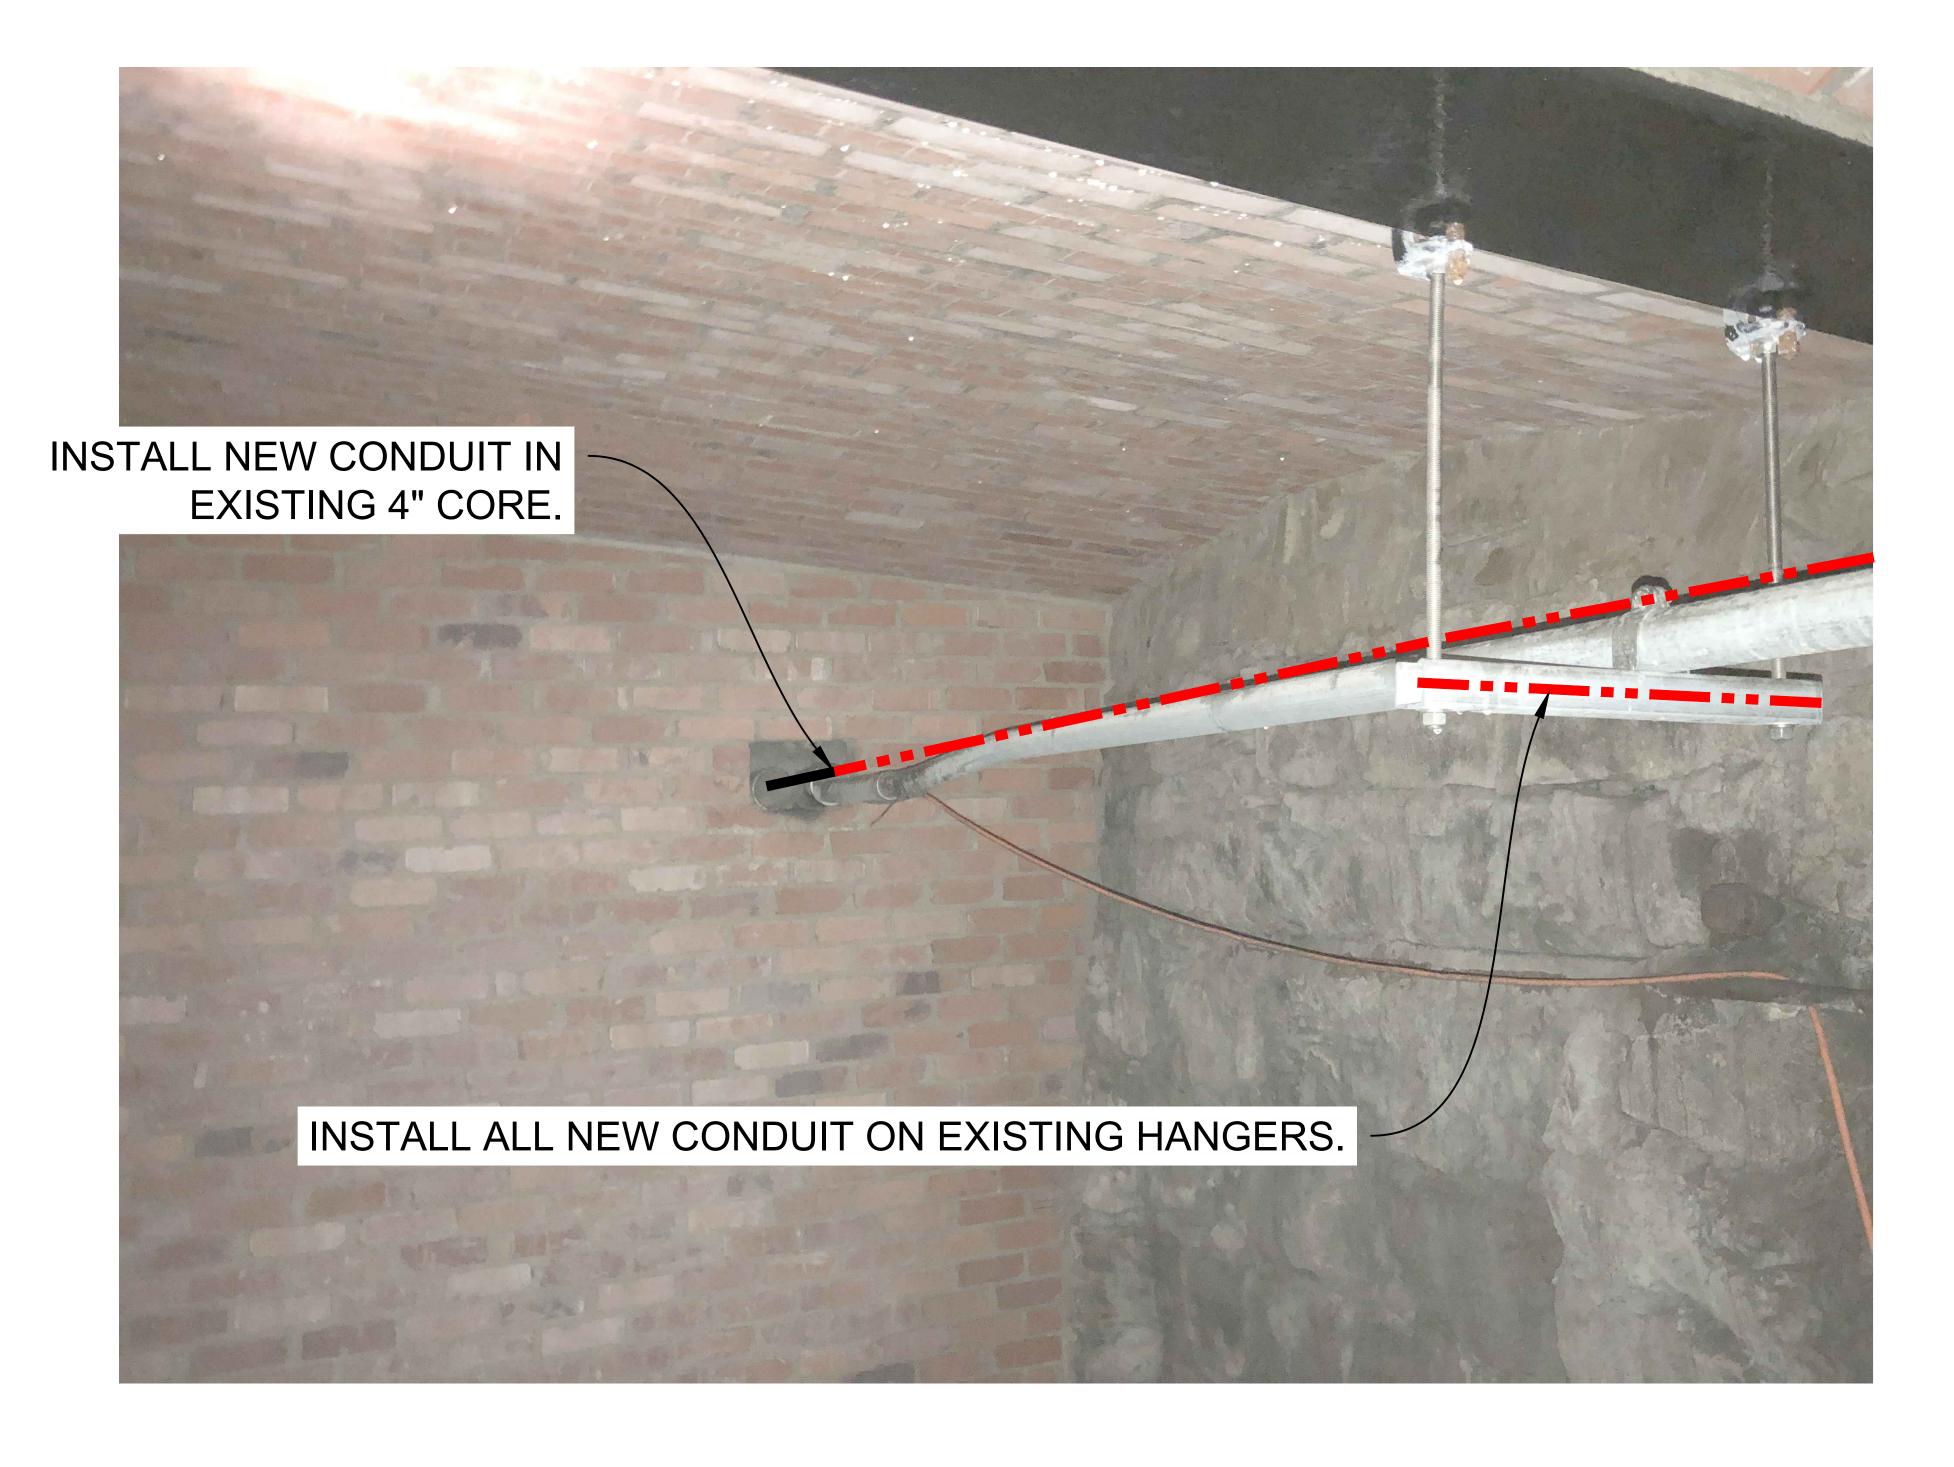




3				AS-BUILT
2	2/17/21	KW	KAW	REVISION # 3
1	8/28/20	MF	DDS	ORIGINAL
NO.	DATE	ENGINEER	DRAFTER	COMMENT
9		ST ork Solu		MGE TECHNICAL CONSULTING INC
CLII	ENT PROJE	CT MANAGE	R: GIN VILA	NTE
ENC	SINEERING	FIRM: MGC	TECHNICAL	CONSULTING INC.
PRO	DJECT NUM	BER: 15586-	-023-E	
LOC	CATION: 515	2ND AVE		
	SE	ATTLE, WA 9	98104	
DRA	AWING NAM	E: MASTEC -	15586-023-E - F	PSPB.dwg
COI	VFIDENTIAL	/PROPRIETA	ARY	SHEET: 10 OF 18

SITE PHOTO 8: FACING WEST IN AREAWAY



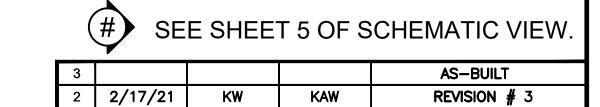



_	_,,			''_''			
1	8/28/20	MF	DDS	ORIGINAL			
NO.	DATE	ENGINEER	DRAFTER	COMMENT			
**MasTec Network Solutions **MasTec **Mastec							
CLI	CLIENT PROJECT MANAGER: GIN VILANTE						
EN	ENGINEERING FIRM: MGC TECHNICAL CONSULTING INC.						
PROJECT NUMBER: 15586-023-E							
LOCATION: 515 2ND AVE							
	SE	ATTLE, WA 9	98104				
DR	AWING NAM	E: MASTEC -	15586-023-E - F	PSPB.dwg			

SHEET: 11 OF 18

CONFIDENTIAL/PROPRIETARY

SITE PHOTO 9: FACING EAST IN AREAWAY

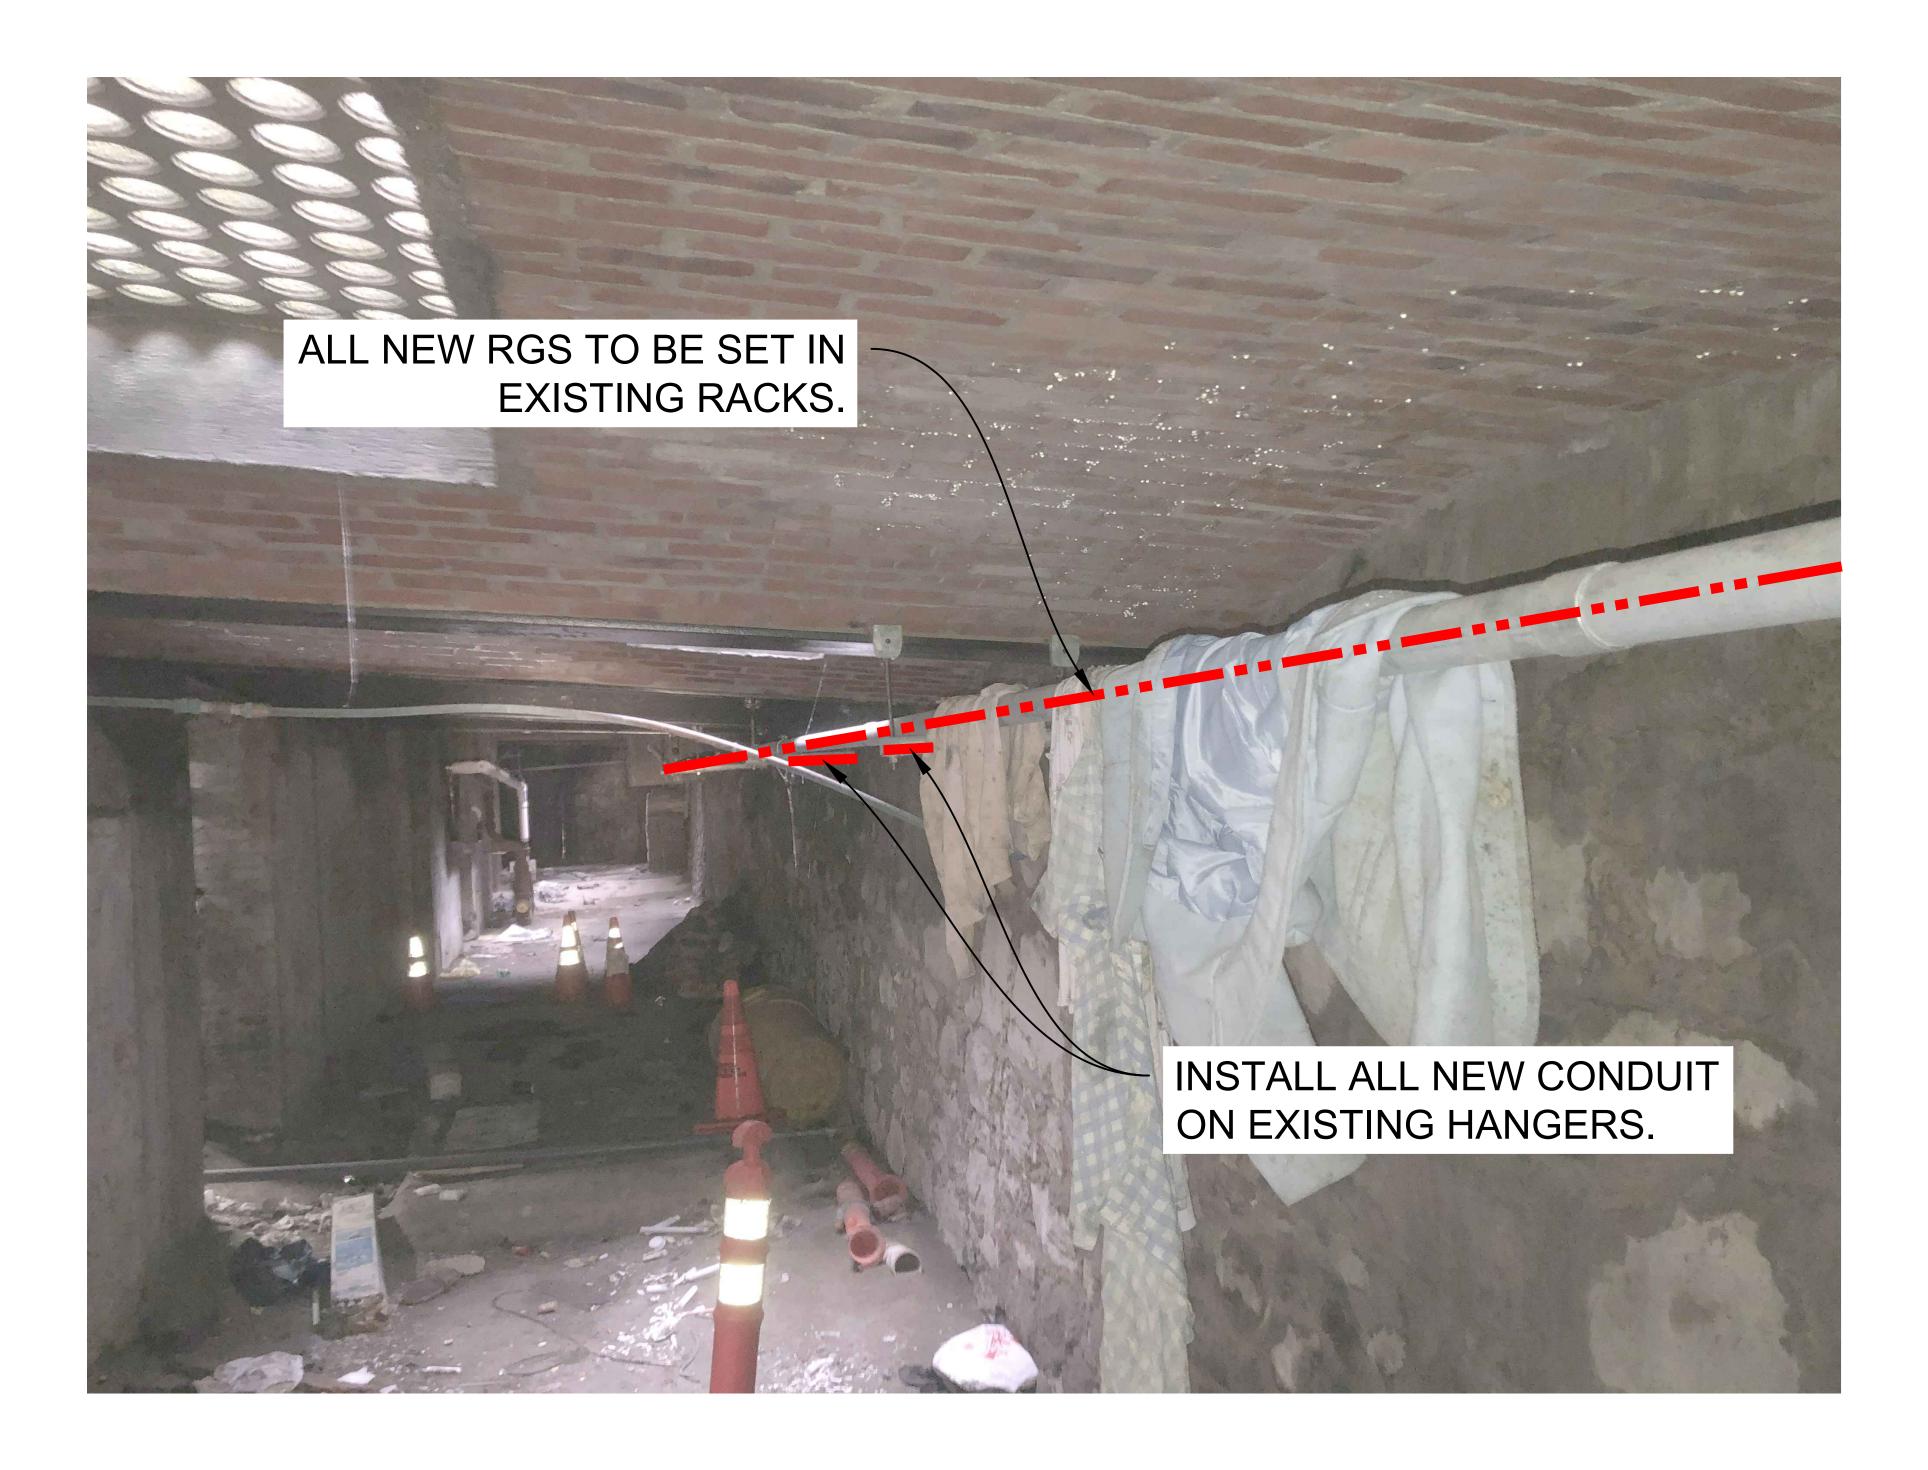

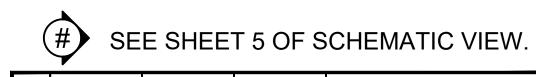

3				AS-BUILT			
2	2/17/21	KW	KAW	REVISION # 3			
1	8/28/20	MF	DDS	ORIGINAL			
NO.	DATE	ENGINEER	DRAFTER	COMMENT			
Ŀ	**Mastec Network Solutions **Mastec **Mastec						
CLI	CLIENT PROJECT MANAGER: GIN VILANTE						
EN	GINEERING	FIRM: MGC	TECHNICAL	CONSULTING INC.			
PR	PROJECT NUMBER: 15586-023-E						
LO	LOCATION: 515 2ND AVE						
	SEATTLE, WA 98104						
DR	AWING NAM	E: MASTEC -	15586-023-E - F	PSPB.dwg			
CO	NFIDENTIAL	/PROPRIETA	ARY	SHEET: 12 OF 18			

SITE PHOTO 10: FACING EAST IN AREAWAY





1	2/17/21 8/28/20	KW MF	DDS DDS	REVISION # ORIGINAL
NO.	DATE	ENGINEER	DRAFTER	COMMENT

Network Solutions

CLIENT PROJECT MANAGER: GIN VILANTE

CLIENT PROJECT MANAGER: GIN VILANTE

ENGINEERING FIRM: MGC TECHNICAL CONSULTING INC.

PROJECT NUMBER: 15586-023-E

LOCATION: 515 2ND AVE SEATTLE, WA 98104

DRAWING NAME: MASTEC - 15586-023-E - PSPB.dwg

CONFIDENTIAL/PROPRIETARY

SHEET: 13 OF 18

SITE PHOTO 11: FACING EAST IN AREAWAY






	3				AS-BUILT		
	2	2/17/21	KW	KAW	REVISION # 3		
	1	8/28/20	MF	DDS	ORIGINAL		
Ν	10.	DATE	ENGINEER	DRAFTER	COMMENT		
	*Mastec Network Solutions MGE TECHNICAL CONSULTING INC						
(CLIENT PROJECT MANAGER: GIN VILANTE						
	ENGINEERING FIRM: MGC TECHNICAL CONSULTING INC.						
	PROJECT NUMBER: 15586-023-E						
Ī	LOCATION: 515 2ND AVE						
		SE	ATTLE, WA 9	98104			
	DR/	AWING NAM	E: MASTEC -	15586-023-E - F	PSPB.dwg		

SHEET: 14 OF 18

SITE PHOTO 12: FACING EAST IN AREAWAY

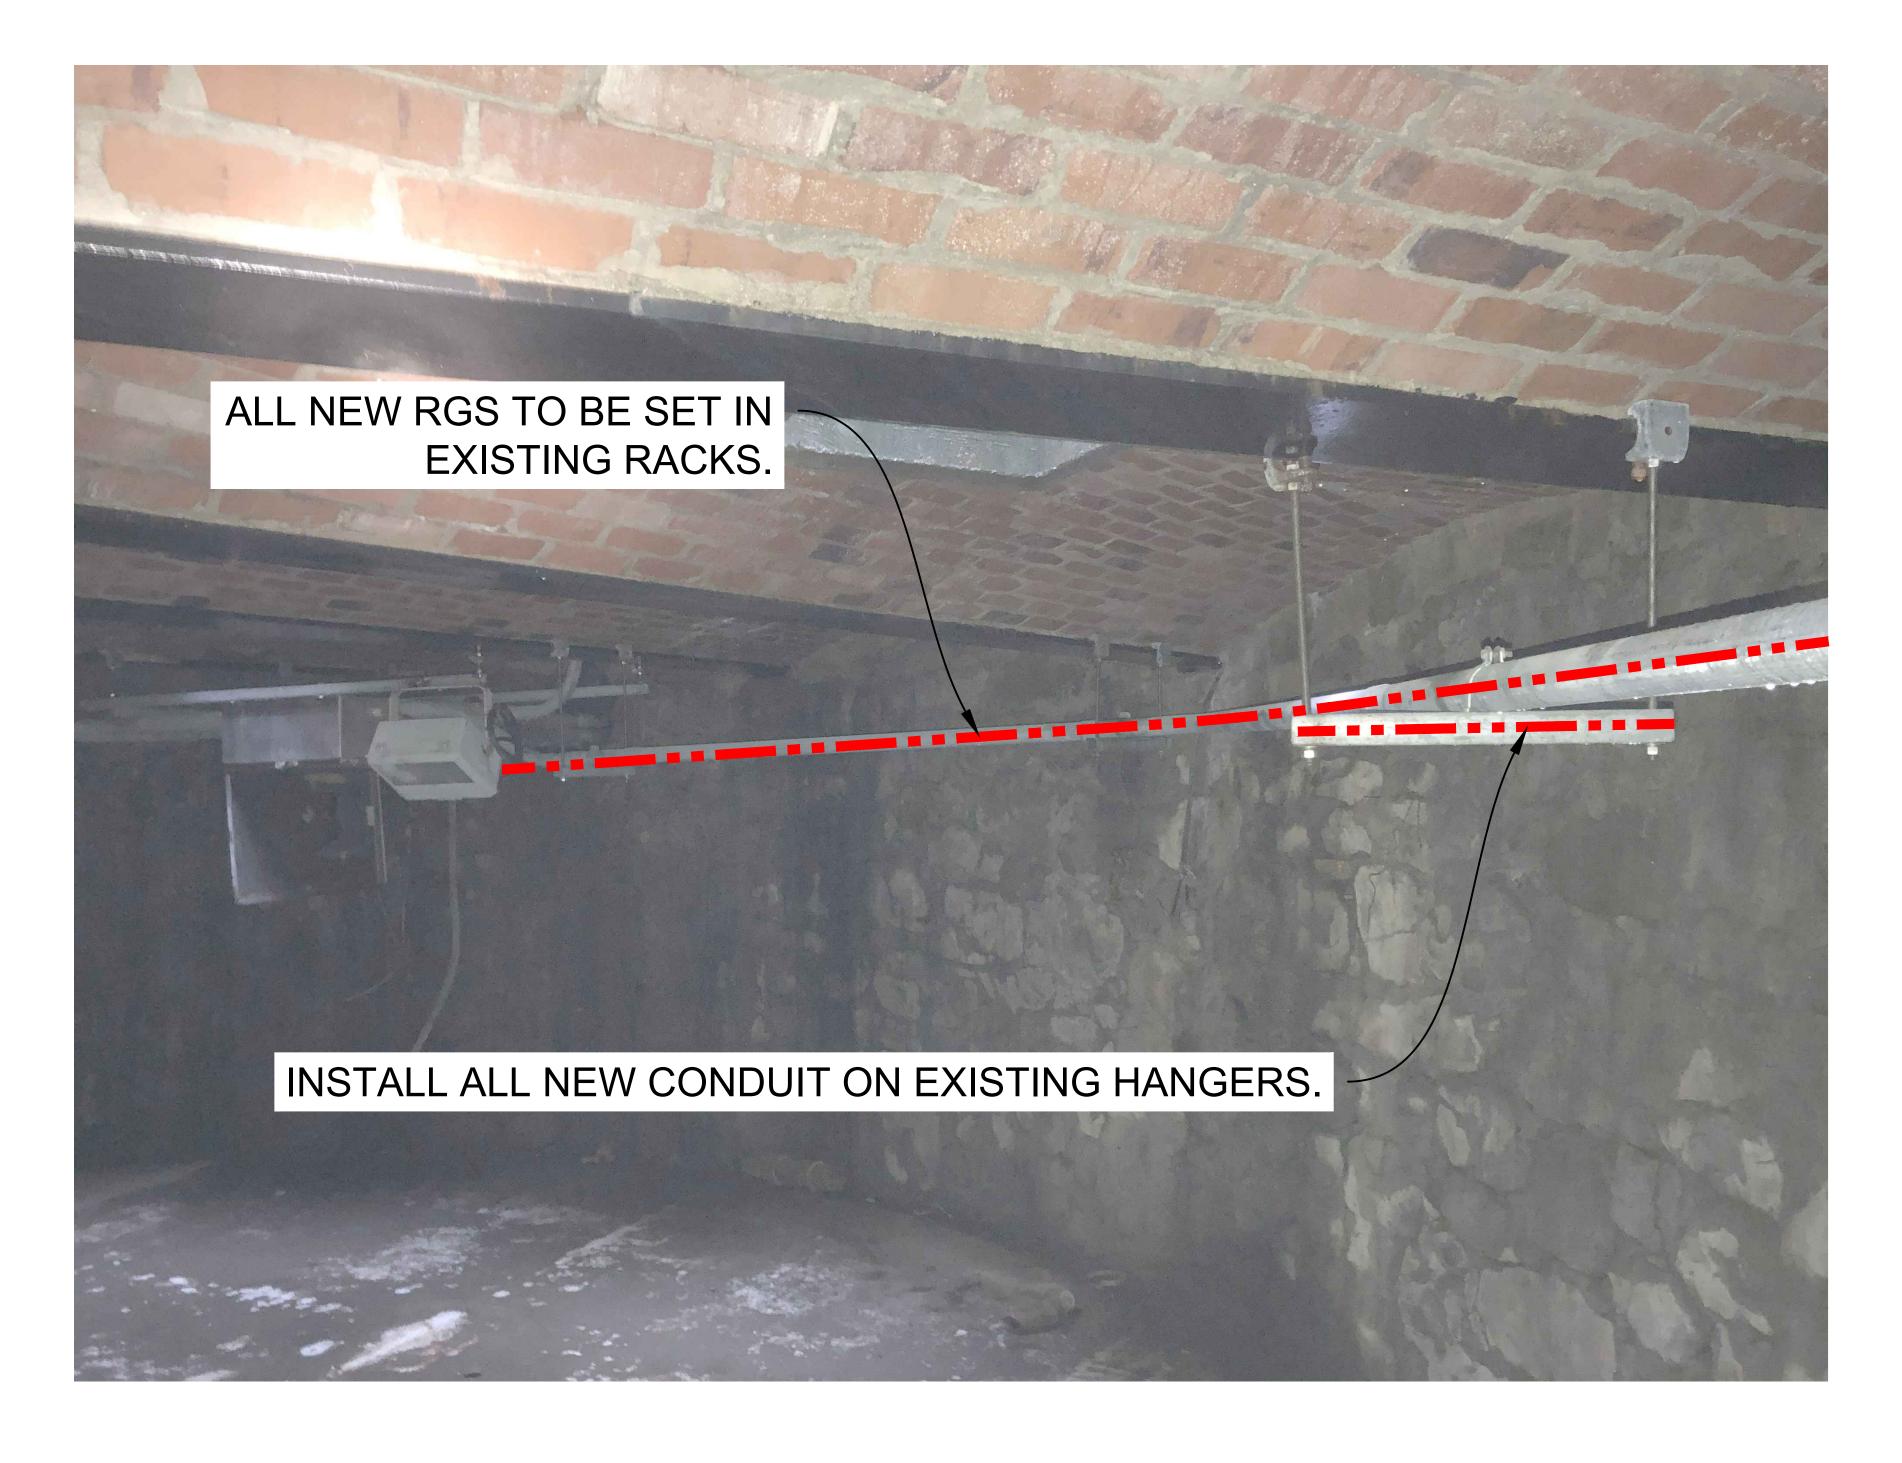



3				AS-BUIL1	Τ		
2	2/17/21	KW	KAW	REVISION	# 3		
1	8/28/20	MF	DDS	ORIGINAL	•		
NO.	DATE	ENGINEER	DRAFTER	COMMENT	Γ		
4	Ma Netwo	ST ork Solu		MG TECHNICAL CONSU			
CLIENT PROJECT MANAGER: GIN VILANTE							
ENGINEERING FIRM: MGC TECHNICAL CONSULTING INC.							
PROJECT NUMBER: 15586-023-E							
LO	CATION: 515	2ND AVE					
	SEA	ATTLE, WA 9	98104				
DR	AWING NAM	E: MASTEC -	15586-023-E - F	PSPB.dwg			
CO	NFIDENTIAL	/PROPRIET <i>A</i>	ARY	SHEET: 1	5 OF	18	

PROJECT DESCRIPTION

THIS PROJECT CONSISTS OF REMOVING AND REPLACING AN EXISTING DECORATIVE STREET LIGHT ON THE NW CORNER OF 2ND AVE AND YESLER WAY. INSTALL EQUIPMENT AS SHOWN IN THE PLAN. ACCESS EXISTING SCL VAULT AND ZAYO VAULT TO TRENCH NEW CONDUIT TO STREET LIGHT AS PER PLANS AND SUPPLY POWER AND COMM TO NEW DECORATIVE STREET LIGHT CELL SITE.

PROJECT INFORMATION

SITE ADDRESS	515 2ND AVE SEATTLE, WA 98104	ZONING:	PSM 100/100-120
LATITUDE:	47.6018810° N	PROPOSED USE:	UNMANNED TELECOMMUNICATIONS FACILITY
Daniobl.	47.0010010 N	OCCUPANCY:	U
LONGITUDE:	-122.3323010° W		
JURISDICTION:	CITY OF CEATTLE	POLE OWNER:	SCL
JURISDICTION:	CITY OF SEATTLE	POWER COMPANY:	SCL
TYPE OF CONSTRUCTION:	IIB	FOWER COMPANI.	30L
		TELCO COMPANY:	ZAYO

CITY OF SEATTLE (ROW)

LOCATION:

	DRAWING INDEX	REV
1	TITLE SHEET	0
2	LEGEND	0
3	GENERAL NOTES	0
4-5	SCHEMATIC VIEW	0
6	GROUNDING DETAILS	0
7–8	POLE ELEVATIONS	0
9-12	POLE SPECIFICATIONS	0
13–14	EQUIPMENT DETAILS	0
15	UNDERGROUND DETAILS	0
16–17	SITE PHOTOGRAPHS	0
18	SIMULATION PHOTOGRAPHS	0
19	RF WARNING SIGN DETAILS	0
20-21	DESIGN VIEW	0
22-23	RESTORATION VIEW	0
24-27	ADA RAMP DETAIL 1-4	

LEGAL DESCRIPTION


CITY OF SEATTLE RIGHT-OF-WAY, ALL WORK BEING PERFORMED TO CONFORM TO SDOT AND SCL STANDARDS AND CODES.



VICINITY MAP

FROM ATT REDMOND OFFICES(16331 NE 72nd Way, Redmond, WA 98052)

Get on WA-520 W from Bear Creek Pkwy and NE Leary Way, Head east on NE 72nd Way toward 164th Ave NE, Turn right onto 164th Ave NE, Turn right onto Bear Creek Pkwy, Use the left 2 lanes to turn left onto NE Leary Way, Use the middle 2 lanes to take the ramp onto WA-520 W, Continue on WA-520 W to Seattle. Take exit 165A from I-5 S Merge onto WA-520 W, Toll road, Use any lane to merge onto I-5 S toward Portland, Parts of this road may be closed at certain times or days, Use the right lane to take exit 165A toward James Street, Continue on 6th Ave to your destination, Use the right lane to merge onto 6th Ave, Turn right onto James St, Continue straight to stay on James St, Turn left onto 2nd Ave, Turn right

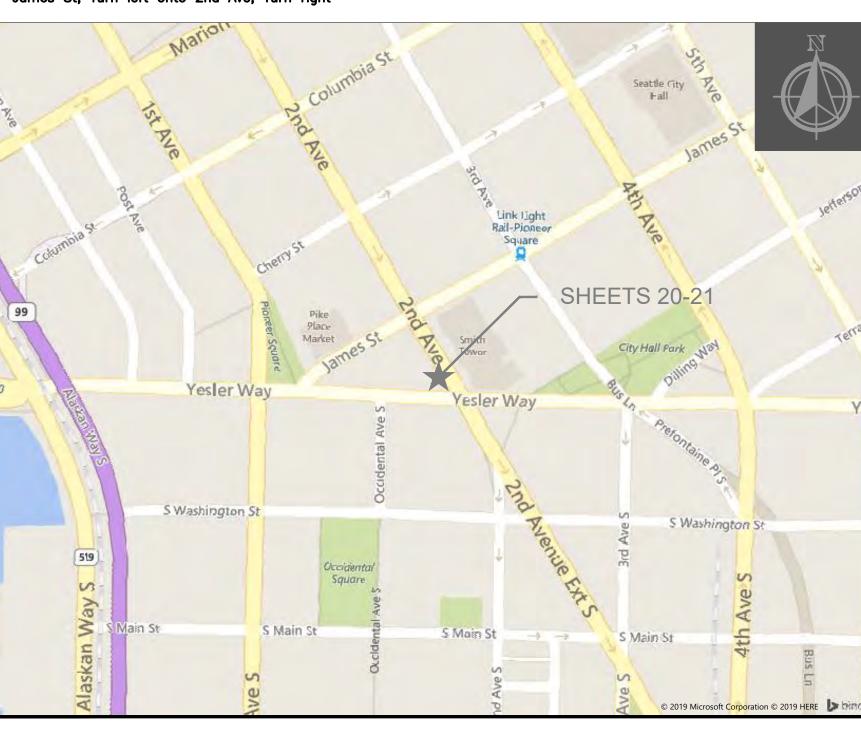

SCALING DRAWINGS

SUBCONTRACTOR SHALL VERIFY ALL PLANS, EXISTING DIMENSIONS & CONDITIONS ON THE JOB SITE & SHALL IMMEDIATELY NOTIFY THE ENGINEER IN WRITING OF ANY DISCREPANCIES BEFORE PROCEEDING WITH THE WORK OR BE RESPONSIBLE FOR THE SAME.

IF USING 11"x17" PLOT, DRAWINGS WILL BE AT HALF SCALE.

SITE PROJECT PARTICIPANTS

	<u>NAME</u>	<u>COMPANY</u>	<u>NUMBER</u>
A/E	MATT FRASER	MGC TECHNICAL CONSULTING	206-618-5254
РМ	DANIEL KELLY	MASTEC NETWORK SOLUTIONS	253-579-3503
СМ	STEVEN EVENSON	MASTEC NETWORK SOLUTIONS	206-499-1359
PM	JUDY FISCHER	AT&T	925-474-7626

DIG INFORMATION



UULC: UTILITIES UNDERGROUND LOCATION CENTER 1-800-424-5555 OR 811

WWW.CALLBEFOREYOUDIG.ORG/WASHINGTON 3 WORKING DAYS UTILITY NOTIFICATION PRIOR TO CONSTRUCTION AT&T SITE ID: DTSEA-023-E MRWOR023152 PACE #: SCIP ID #: 15586-023-E USID #: 179088 14804831

POLE TYPE: DECORATIVE ALADDIN POLE

POLE #: 1313162 NEAREST ADDRESS:

515 2ND AVE SEATTLE, WA 98104

0939000005 NEAREST PARCEL#:

CONVO #: 931477

CONSTRUCTION DRAWINGS

BUILDING CODES AND STANDARDS

SUBCONTRACTOR'S WORK SHALL COMPLY WITH ALL APPLICABLE NATIONAL, STATE, AND LOCAL CODES AS ADOPTED BY THE LOCAL AUTHORITY HAVING JURISDICTION (AHJ) FOR THE LOCATION. THE EDITION OF THE AHJ ADOPTED CODES AND STANDARDS IN EFFECT ON THE DATE OF CONTRACT AWARD SHALL GOVERN THE DESIGN.

BUILDING CODE:

[INTERNATIONAL BUILDING CODE (IBC), 2018 AS ADOPTED BY THE LOCAL JURISDICTION]

ELECTRICAL CODE:

FA #:

[NATIONAL FIRE PROTECTION ASSOCIATION (NFPA) 70 - 2015, NATIONAL ELECTRICAL CODE, AS ADOPTED BY THE LOCAL JURISDICTION] LIGHTNING PROTECTION CODE:

[NFPA 780 - 2002, LIGHTNING PROTECTION CODE]

SUBCONTRACTOR'S WORK SHALL COMPLY WITH THE LATEST EDITION OF THE FOLLOWING STANDARDS. AMERICAN CONCRETE INSTITUTE (ACI) 318, BUILDING CODE REQUIREMENTS FOR STRUCTURAL CONCRETE AMERICAN INSTITUTE OF STEEL CONSTRUCTION (AISC), MANUAL OF STEEL CONSTRUCTION, ASD, THIRTEENTH EDITION ANSI/TIA 222-G, STRUCTURAL STANDARDS FOR ANTENNA SUPPORTING STRUCTURES AND ANTENNAS.

TIA 607, COMMERCIAL BUILDING GROUNDING AND BONDING REQUIREMENTS FOR TELECOMMUNICATIONS

INSTITUTE FOR ELECTRICAL AND ELECTRONICS ENGINEERS (IEEE) 81, GUIDE FOR MEASURING EARTH RESISTIVITY, GROUND IMPEDANCE, AND EARTH SURFACE POTENTIALS OF A GROUND SYSTEM IEEE 1100 (1999) RECOMMENDED PRACTICE FOR POWERING AND GROUNDING OF ELECTRONIC EQUIPMENT

IEEE C2 NATIONAL ELECTRIC SAFETY CODE, LATEST VERSION

TELCORDIA GR-1275, GENERAL INSTALLATION REQUIREMENTS

ANSI T1.311, FOR TELECOM - DC POWER SYSTEMS - TELECOM, ENVIRONMENTAL PROTECTION

FOR ANY CONFLICTS BETWEEN SECTIONS OF LISTED CODES AND STANDARDS REGARDING MATERIAL, METHODS OF CONSTRUCTION, OR OTHER REQUIREMENTS, THE MOST RESTRICTIVE REQUIREMENT SHALL GOVERN. WHERE THERE IS CONFLICT BETWEEN A GENERAL REQUIREMENT AND A SPECIFIC REQUIREMENT, THE SPECIFIC REQUIREMENT SHALL GOVERN.

EXISTING SITE PHOTOGRAPH



PROJECT ENGINEER STAMP

2	2/17/21 3/23/20	KW MF	KAW DDS	REVISION # 4 ORIGINAL
NO.	DATE	ENGINEER	DRAFTER	COMMENT





CLIENT PROJECT MANAGER: GIN VILANTE **ENGINEERING FIRM: MGC TECHNICAL CONSULTING INC.** PROJECT NUMBER: 15586-023-E PERMIT #:421117

LOCATION: 515 2ND AVE SEATTLE, WA 98104

DRAWING NAME: MASTEC - 15586-023-E - PLANS.dwg

CONFIDENTIAL/PROPRIETARY

SHEET: 1 OF 27

LEGEND

LINETYPES AERIAL FIBER — EXISTING AERIAL FIBER - ATTACH AERIAL FIBER - OVERLASH STRAND - EXISTING STRAND - PROPOSED CONDUIT - EXISTING CONDUIT - PROPOSED INNERDUCT - EXISTING INNERDUCT - PROPOSED GAS TELEPHONE FIBER OPTIC **ELECTRIC** SANITARY SEWER (SEW) STORM DRAIN CABLE TV STEAM ----OIL----UNKNOWN UTILITY **FENCE** RIGHT OF WAY -R/W-EDGE OF PAVEMENT -EOP-

<u>ABBREV</u>	IATIONS
ASW	ASPHALT SIDEWALK
BIP	BLACK IRON PIPE
BSP	BLACK STEEL PIPE
CSW	CONCRETE SIDEWALK
ELECT.	ELECTRIC
EOP	EDGE OF PAVEMENT
EOTW	EDGE OF TRAVEL WAY
FOC	FACE OF CURB
F/0	FIBER OPTIC
HDPE	HIGH DENSITY POLYETHYLENE
HH	HANDHOLE
JB	JUNCTION BOX
MH	MANHOLE
MP	MILE POST
0/S	OFFSET
PR	POWER RISER
PVC	POLY VINYL CHLORIDE
RGS	RIGID GALVANIZED STEEL CONDUIT
ROW	RIGHT OF WAY
SEW	SANITARY SEWER
SD	STORM DRAIN
STA.	STATION
STM	STEAM
TEL	TELECOM

SYMBOLS



RISER - EXISTING



RISER - PROPOSED




CATCH BASIN/INLET (RECTANGULAR)


CATCH BASIN/INLET (ROUND)



FIRE HYDRANT

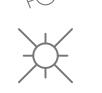

WATER/GAS VALVE LIGHT POST

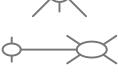

STREET LIGHT





TREE

CULVERT



BRIDGE



STREET SIGN

WING WALL



ADA RAMP



UTILITY POLE - EXISTING



UTILITY POLE - PROPOSED



(SIZE AND UTILITY TYPE MAY VARY)

TRAFFIC RATED VAULT - PROPOSED

TRAFFIC RATED VAULT — EXISTING



(SIZE MAY VARY)



HANDHOLE - EXISTING (SIZE AND UTILITY TYPE MAY VARY)



HANDHOLE - PROPOSED (SIZE MAY VARY)



PEDESTAL - EXISTING (SIZE AND UTILITY TYPE MAY VARY)



PEDESTAL - PROPOSED (SIZE MAY VARY)



WET UTILITY MANHOLE - EXISTING (SIZE AND UTILITY TYPE MAY VARY)



BORE PIT - PROPOSED (SIZE MAY VARY)



UTILITY POTHOLE



TRANSMISSION/DISTRIBUTION POLE




DISTRIBUTION POLE

TRANSMISSION POLE




GROUND/BOND

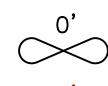

AERIAL STORAGE - EXISTING



AERIAL STORAGE - PROPOSED

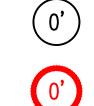

VAULT/BUILDING STORAGE - PROPOSED

VAULT/BUILDING STORAGE - EXISTING



POLE ANCHOR/DOWN GUY - EXISTING



DOWN GUY TO EXISTING ANCHOR - PROPOSED

POLE ANCHOR/DOWN GUY - PROPOSED



SPLICE POINT - PROPOSED

SPLICE POINT - EXISTING



TERMINATION - EXISTING



TERMINATION - PROPOSED



PULLBOX - EXISTING



PULLBOX - PROPOSED



CONSTRUCTION NOTE / RESTORATION CALLOUT



PHOTO-MARKER




NORTH ARROW


INFORMATION TABLES

POLE NUMBER	#
EXISTING UTILITY	0'-0"
PROPOSED ATTACH	0'-0"


UTILITY POLE INFORMATION TABLE (NUMBER OF ATTACHMENTS MAY VARY)

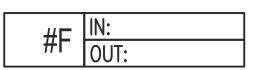

SEQUENTIAL IN/OUT CALLOUT

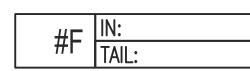

SEQUENTIAL IN/TAIL CALLOUT

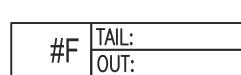


SEQUENTIAL TAIL/OUT CALLOUT


HATCH PATTERNS




CONCRETE SIDEWALK

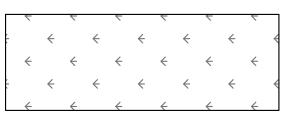

GRASS/VEGETATION

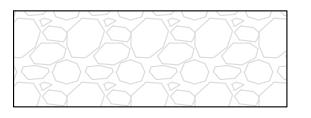

GRAVEL

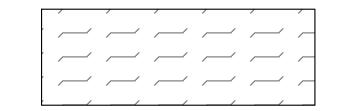

Know what's below.

Call before you dig.

WATER

PROJECT ENGINEER STAMP


3 2 1	2/17/21 3/23/20	KW MF	KAW DDS	AS-BUILT REVISION # 4 ORIGINAL
NO.	DATE	ENGINEER	DRAFTER	COMMENT
3	Мa	ST	ec	MGE



CLIENT PROJECT MANAGER: GIN VILANTE **ENGINEERING FIRM: MGC TECHNICAL CONSULTING INC.** PROJECT NUMBER: 15586-023-E PERMIT #:421117 LOCATION: 515 2ND AVE

SEATTLE, WA 98104 DRAWING NAME: MASTEC - 15586-023-E - PLANS.dwg

CONFIDENTIAL/PROPRIETARY SHEET: 2 OF 27

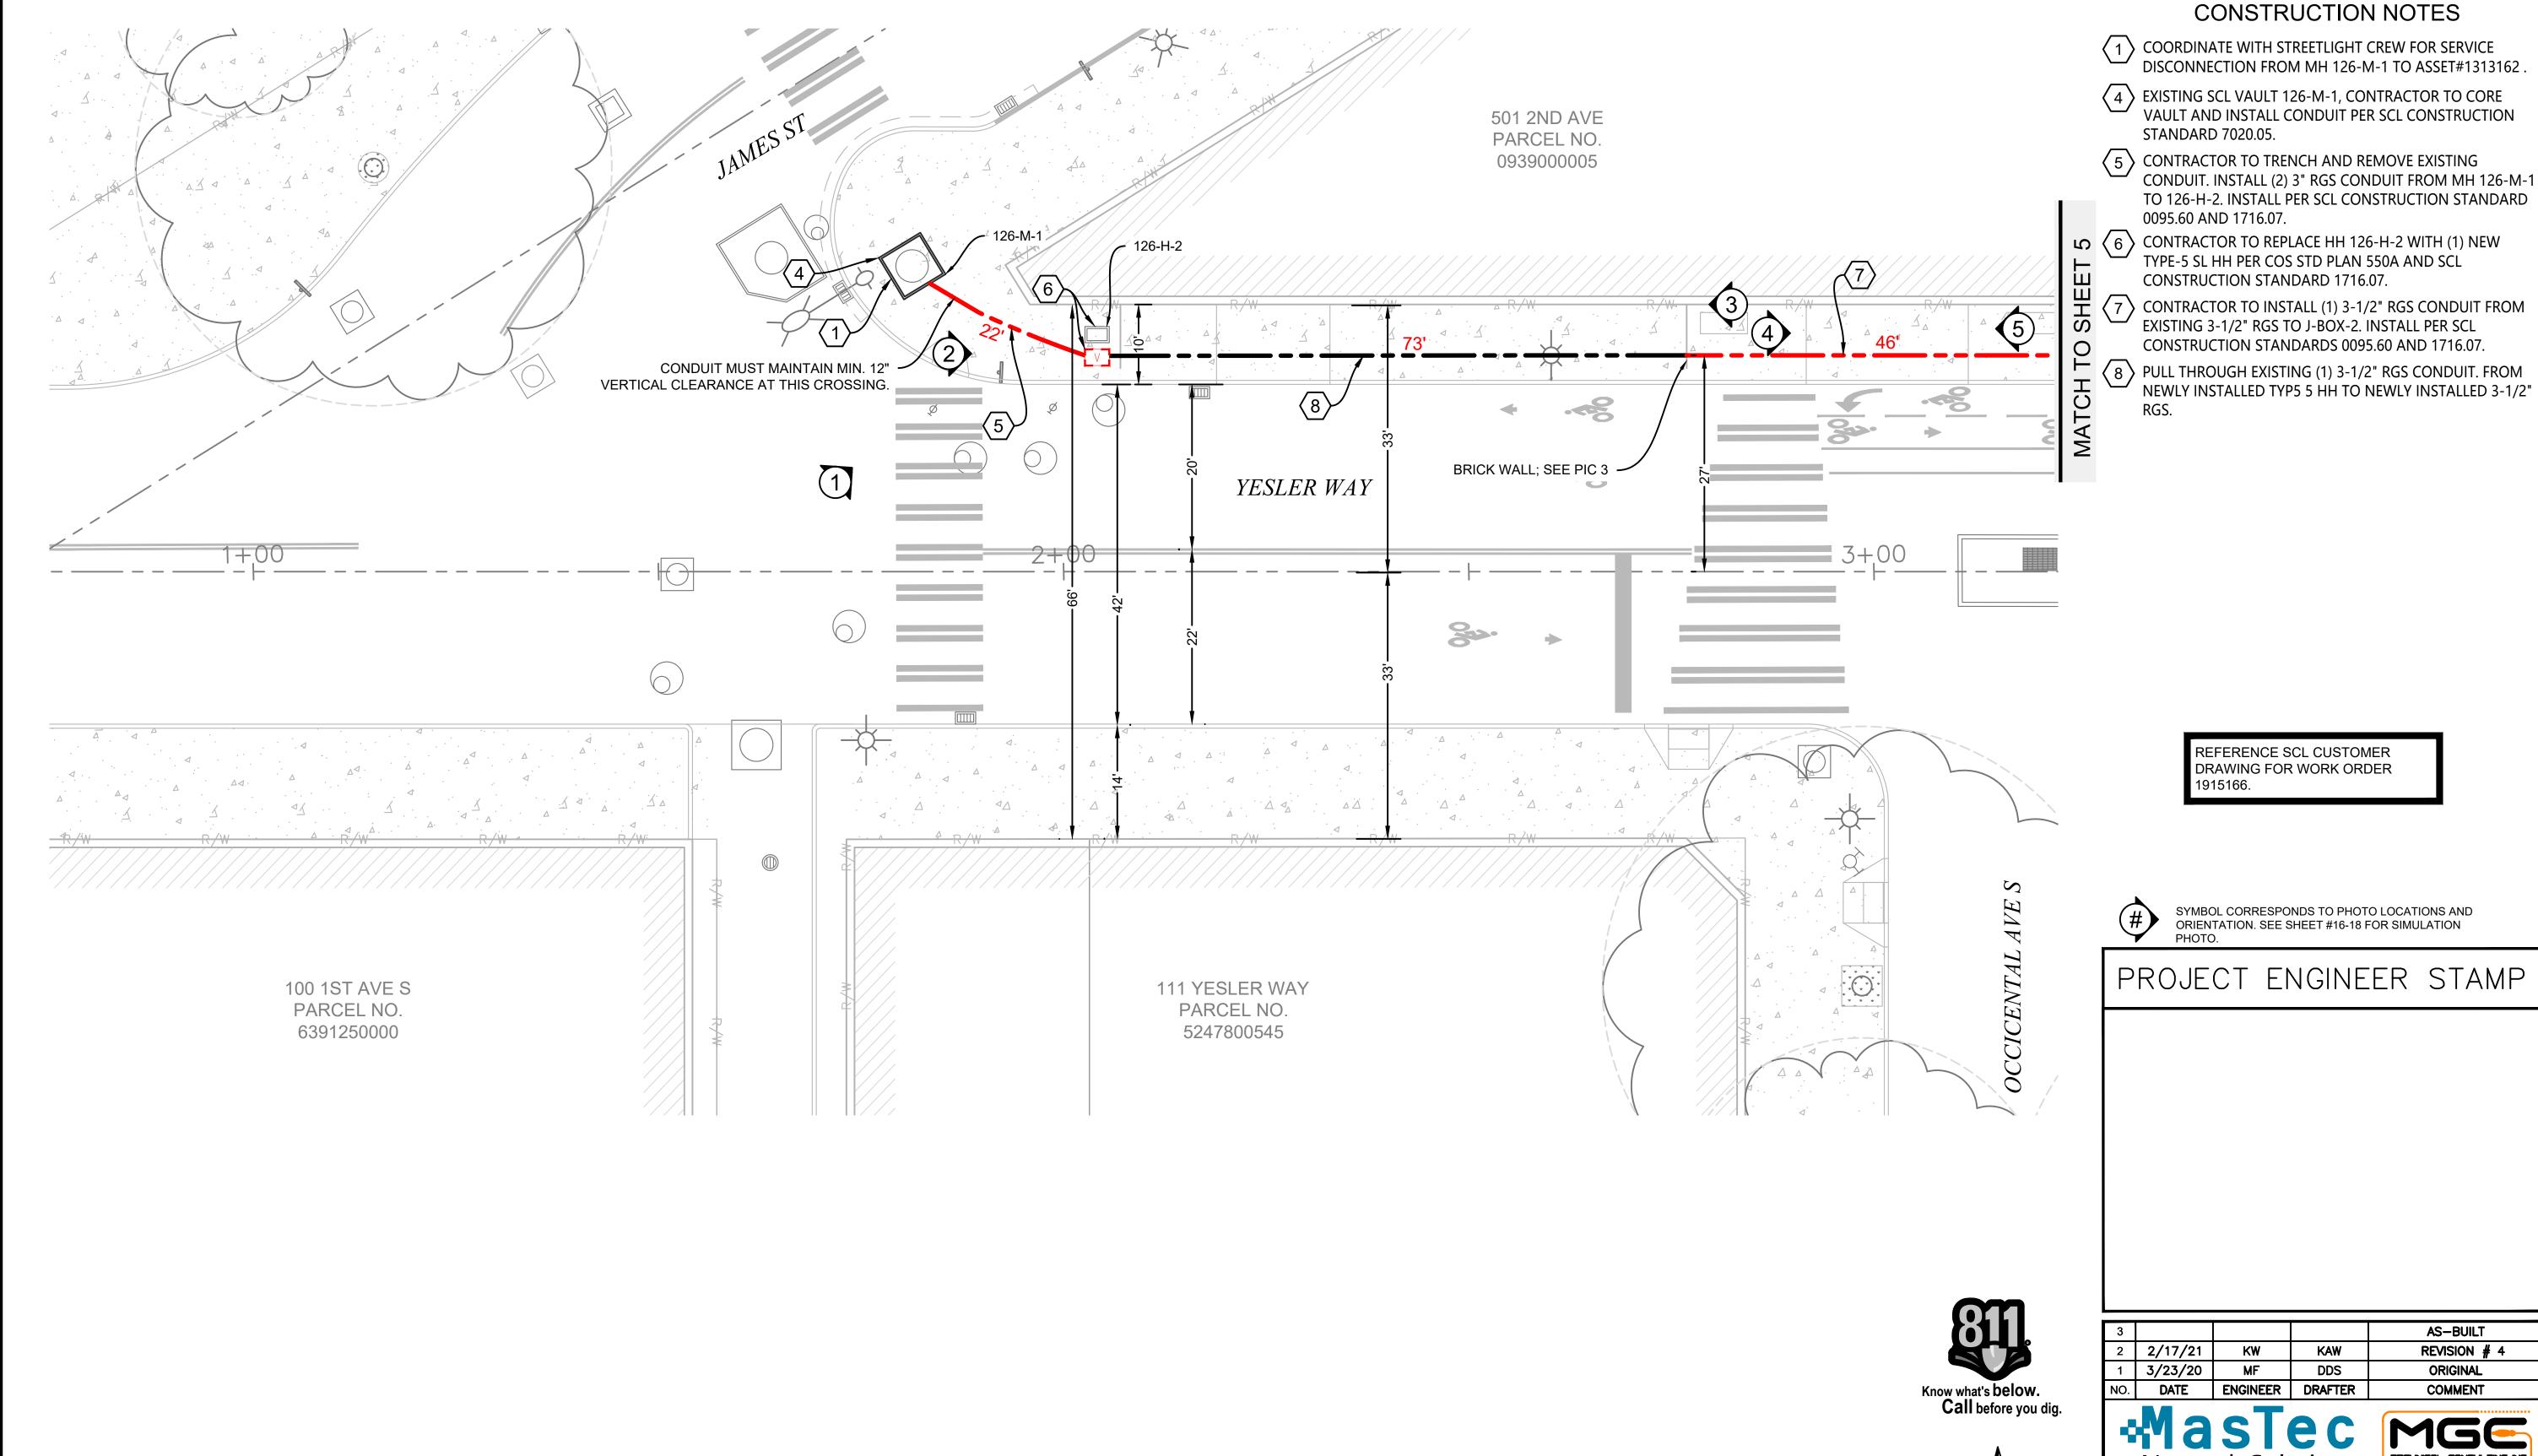

SCALE: 1"=10'

Network Solutions

CLIENT PROJECT MANAGER: GIN VILANTE


ENGINEERING FIRM: MGC TECHNICAL CONSULTING INC. PROJECT NUMBER: 15586-023-E PERMIT #:421117 LOCATION: 515 2ND AVE

SEATTLE, WA 98104

DRAWING NAME: MASTEC - 15586-023-E - PLANS.dwg

CONFIDENTIAL/PROPRIETARY SHEET: 4 OF 27


SCHEMATIC VIEW A

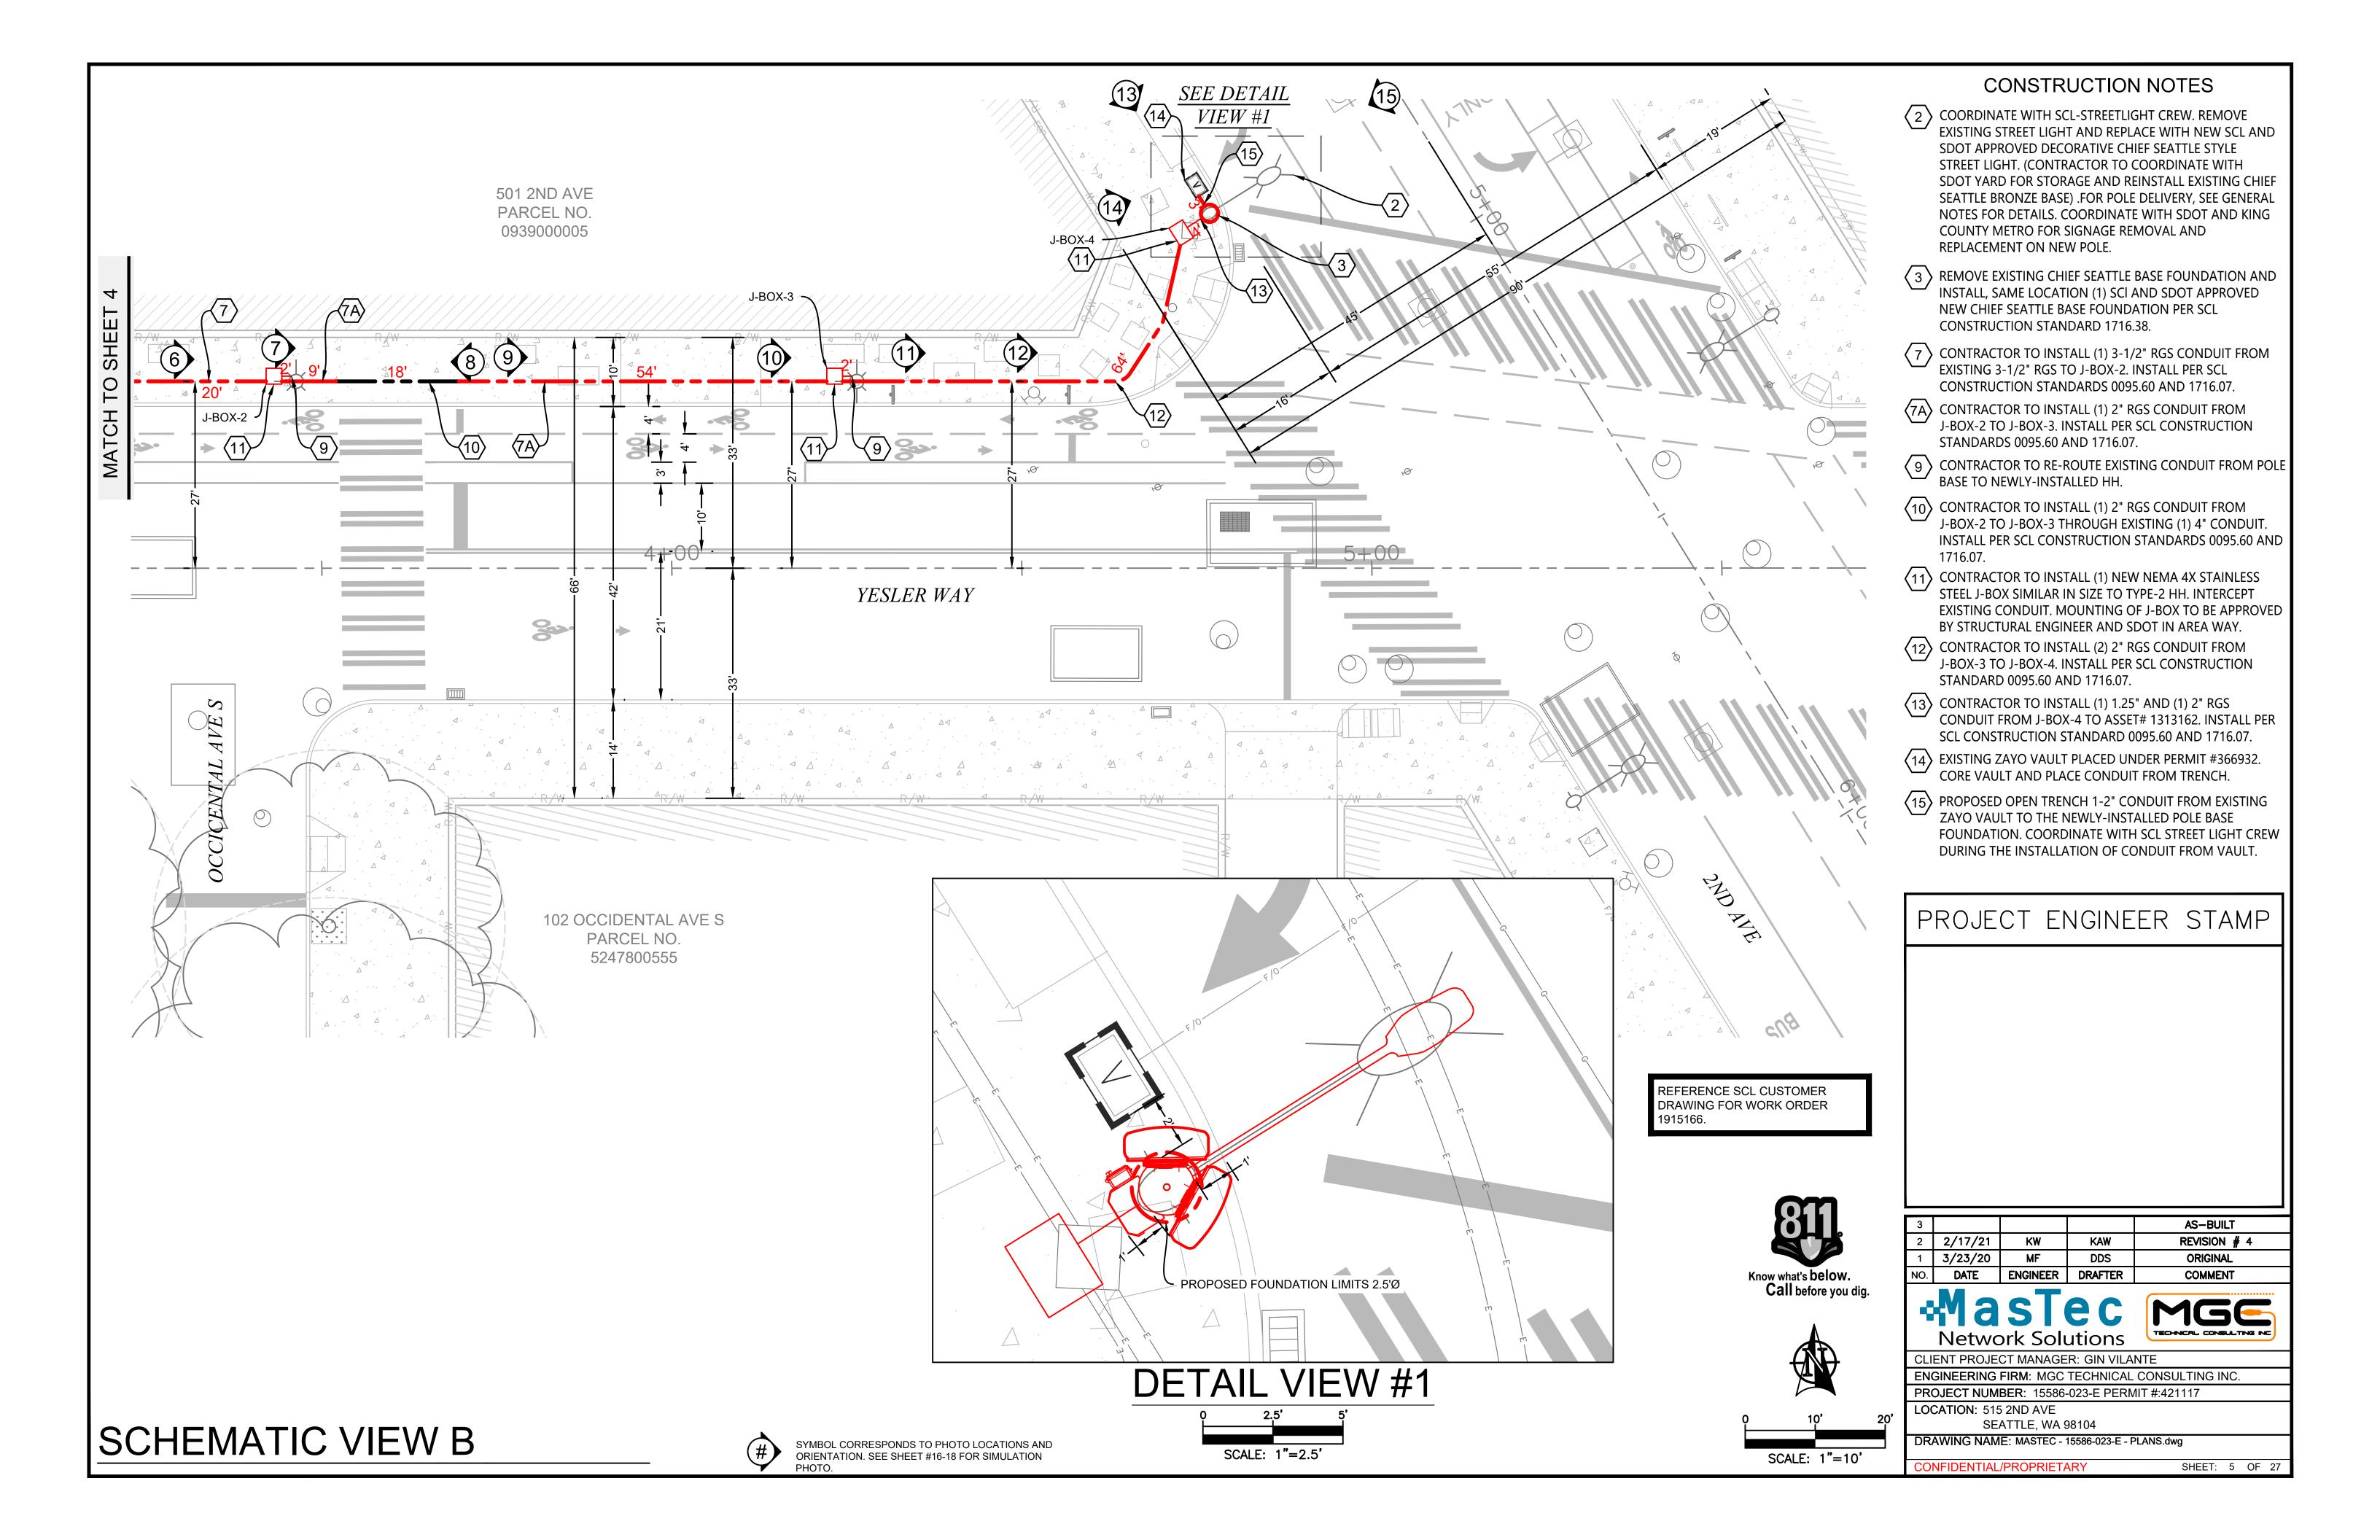


GROUNDING DETAILS

NOTES:

- 1. CROUND WIRE MOLDING SHALL BE INSTALLED OVER THE BARE GROUND WIRE TO PROTECT LINE WORKERS, THE WIRE, AND THE PUBLIC. EXTEND PLASTIC MOLDING AT LEAST TWO INCHES BELOW GRADE.
- 2. THE GROUND WIRE SHALL BE IN ONE CONTINUOUS LENGTH, INSERT GROUND WIRE FROM THE BOTTOM OF THE GROUND CLAMP AND BOND OVER CLAMP BEFORE TIGHTENING, CONNECT TO SECONDARY OR SERVICE NEUTRAL ON THE POLE, PLACE CROUND WIRE ON POLE BETWEEN FACE (NOTCH SIDE) AND SERVICE NEUTRAL
- 3. DROVE GROUND ROD IN FORM UNDISTURBED EARTH
- 4. REFERENCE SEATTLE CITY LIGHT STD 0451.01

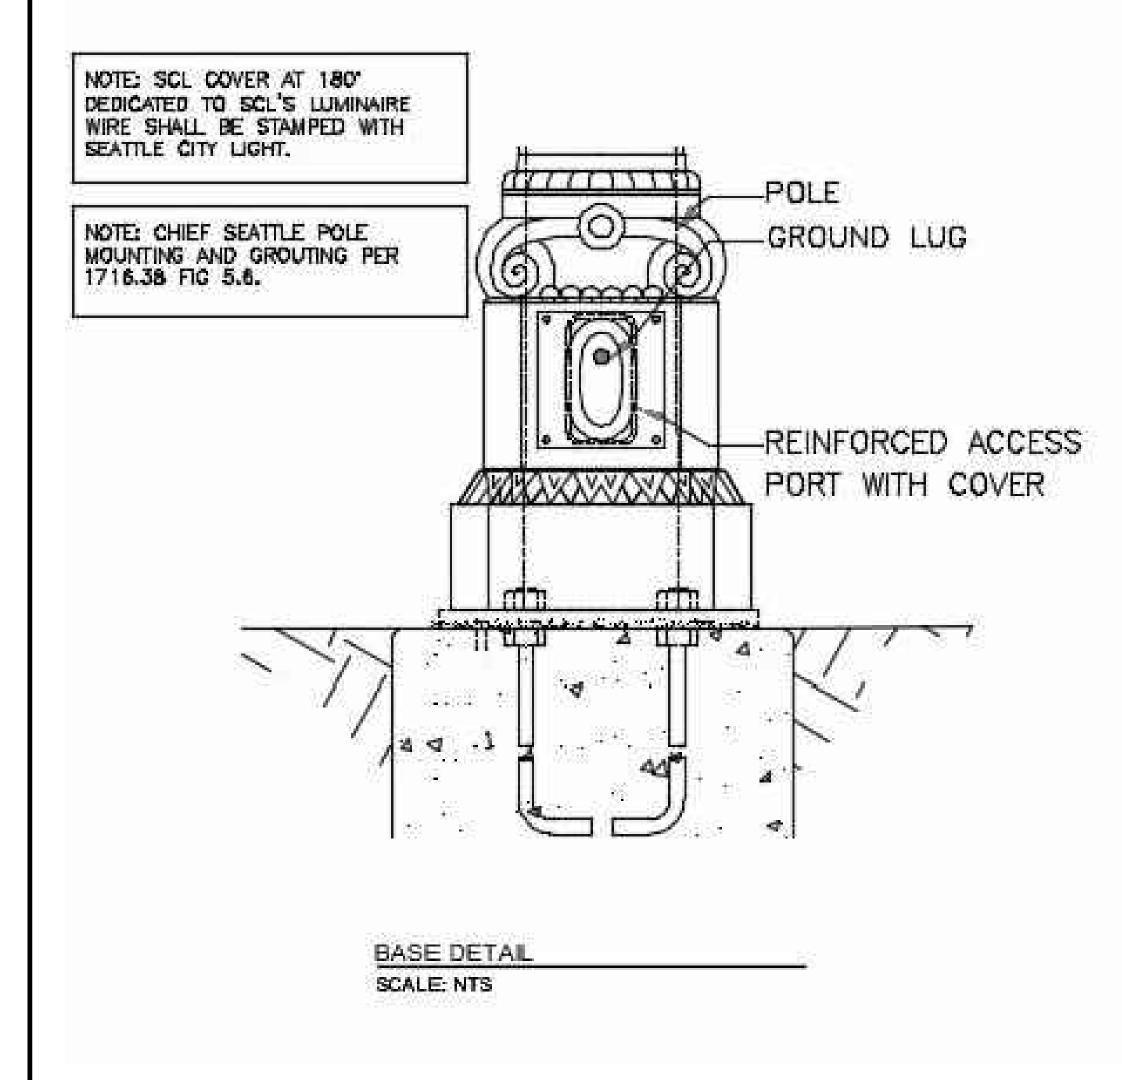

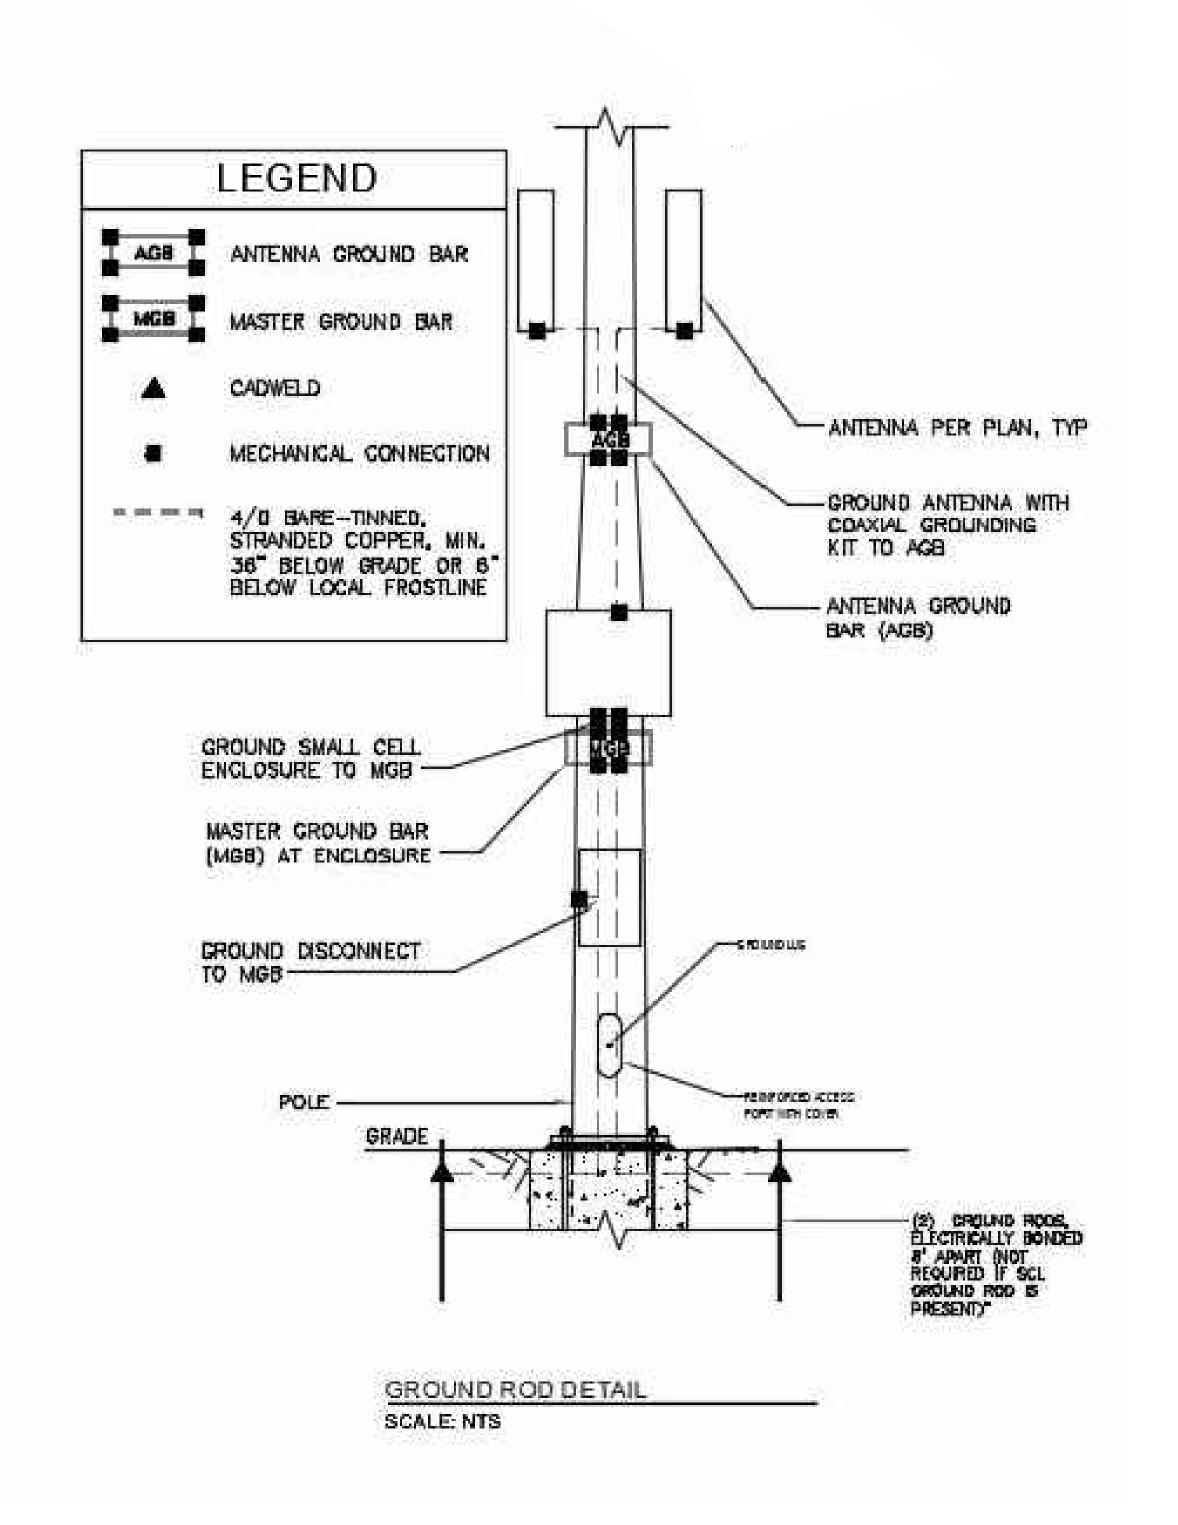

GROUNDING NOTES:

- 1. ALL METALLIC PARTS OF THE INSTALLATION ON THE POLE SHALL BE BONDED TOGETHER AND GROUNDED.
- 2. A COPPER GROUND WIRE, #6 AWG MINIMUM SIZE SHALL BE INSTALLED FROM THE BASE OR FEEDLINE CONNECTION POINT OF THE ANTENNA TO A GROUND ROD AT THE BASE OF THE POLE AND BE ADJACENT TO THE ANTENNA FFEDLINE CONDUIT. THE GROUND WIRE SHALL BE PERMANENTLY CONNECTED TO THE GROUND ROD.
- 3. WHERE A SCL NEUTRAL CONDUCTOR EXISTS, THE GROUND WIRE SHALL BE PERMANENTLY BONDED TO THE SCL NEUTRAL CONDUCTOR AT THE NEUTRAL CONDUCTOR LEVEL BY SCL SCREWS.
- 4. A GROUND ROD, 8 FEET MINIMUM IN LENGTH SHALL BE INSTALLED (WHERE NO SCL GROUND ROD & INTACT GROUND WIRE EXISTS) AT THE REQUIREMENTS OF CONSTRUCTION GUIDELINE D16-2.
- 5. THE GROUND WIRE SHALL BE COVERED BY A PROTECTIVE MOLDING
- MUST BE EXPOSED FOR BONDING TO THE SCL NEUTRAL. 6. THE SCL AND COMMUNICATION GROUND RODS SHALL BE BONDED TOGETHER USING COPPER #6 AWG WIRE.

ITS ENTIRE LENGTH ON THE POLE EXCEPT AT THE POINT WHERE IT

PROJECT ENGINEER STAMP

3				AS-BUILT
2	2/17/21	KW	KAW	REVISION # 4
1	3/23/20	MF	DDS	ORIGINAL
NO.	DATE	ENGINEER	DRAFTER	COMMENT



Know what's below.

Call before you dig.

CLIENT PROJECT MANAGER: GIN VILANTE

ENGINEERING FIRM: MGC TECHNICAL CONSULTING INC. PROJECT NUMBER: 15586-023-E PERMIT #:421117 LOCATION: 515 2ND AVE

SEATTLE, WA 98104


CONFIDENTIAL/PROPRIETARY

DRAWING NAME: MASTEC - 15586-023-E - PLANS.dwg SHEET: 6 OF 27

POLE ELEVATION

NOTES:

- ELEVATION IS DIAGRAMMATIC ONLY.
- 2. NEW EQUIPMENT TO BE PAINTED SHERWIN-WILLIAMS POWDURA TGIC POWDER COATING, DGS2-40003, RAILROAD GREE, RF TRANSPARENT, UV RESISTANT, OUTDOOR RATED PAINT.
- 3. INSTALL RF WARNING SIGNS PER MANUFACTURER SPECIFICATIONS.
- 4. CONTRACTOR SHALL RE-INSTALL ALL EXISTING SIGNAGE AND APPURTENANCES ONTO PROPOSED POLE AS REQUIRED.
- 5. NEW STREET LIGHT AND ARM COLOR AND FINISH TO MATCH EXISTING STREET LIGHT.
- SEE SHEET 9-12 FOR DETAILED POLE SPECIFICATIONS.
- 7. EXISTING BRONZE BASE. CONTRACTOR TO COORDINATE
- WITH SDOT YARD STORAGE FOR FUTURE USE.

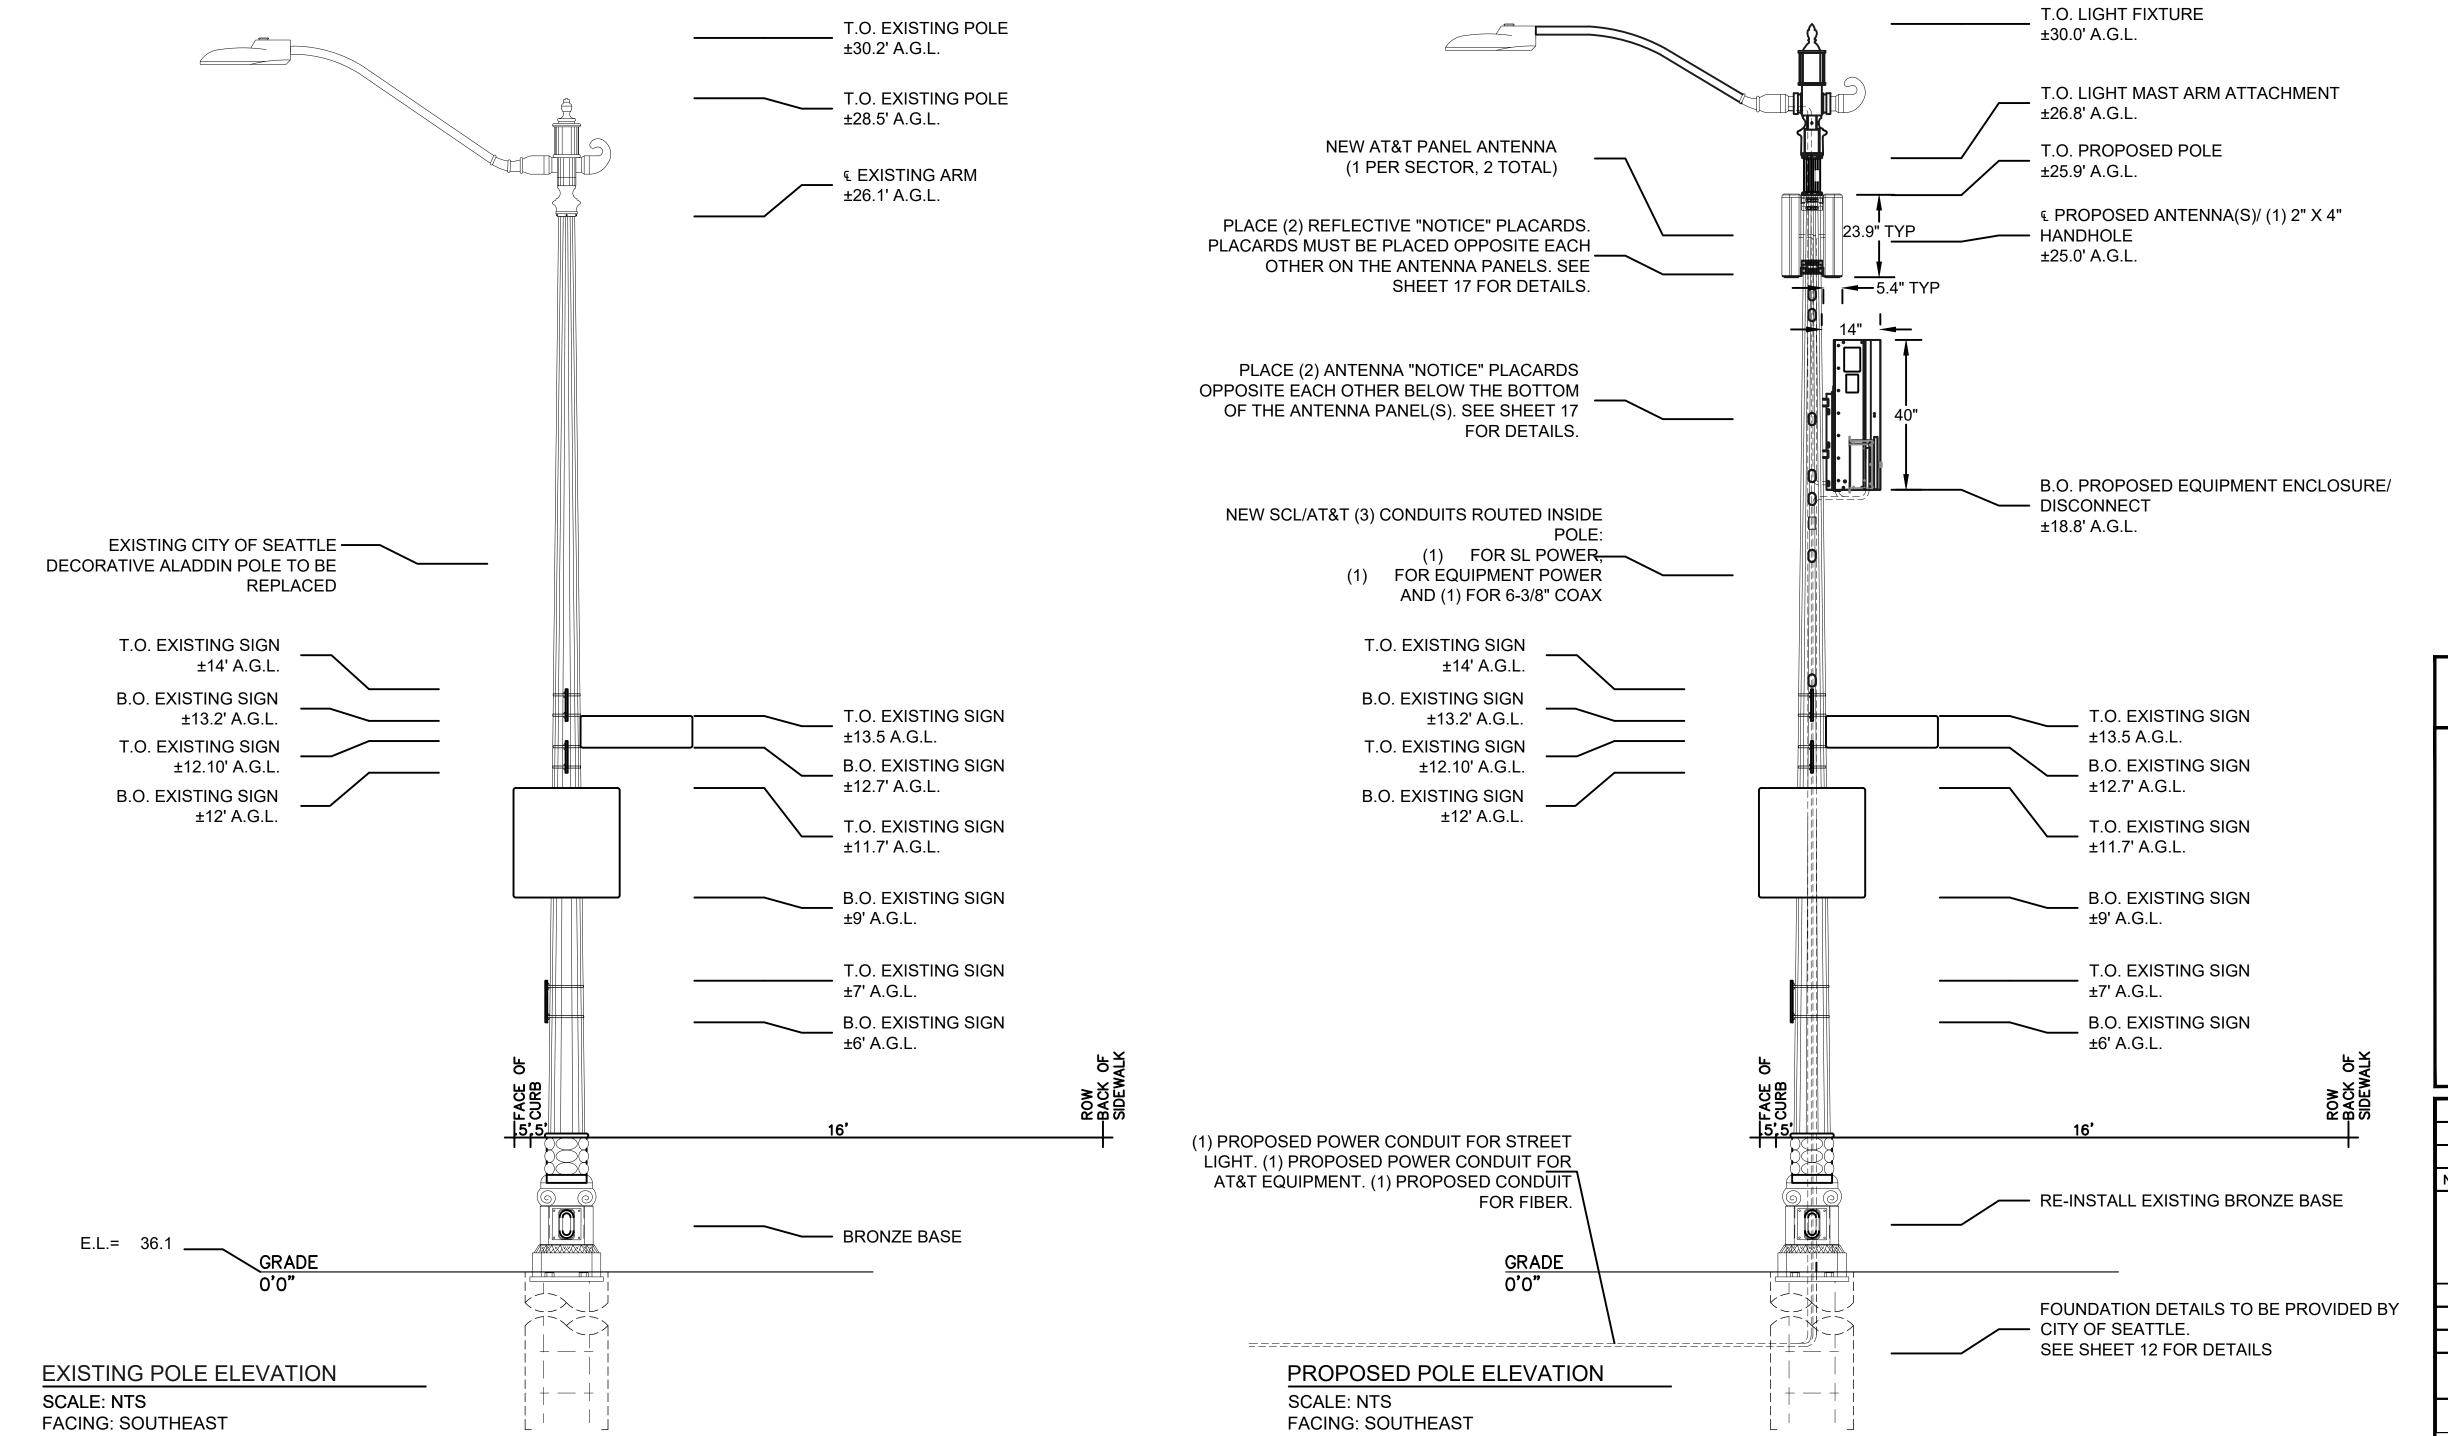



PROJECT ENGINEER STAMP

 3
 AS-BUILT

 2
 2/17/21
 KW
 KAW
 REVISION # 4

 1
 3/23/20
 MF
 DDS
 ORIGINAL

 NO.
 DATE
 ENGINEER
 DRAFTER
 COMMENT





Network Solutions

CLIENT PROJECT MANAGER: GIN VILANTE

ENGINEERING FIRM: MGC TECHNICAL CONSULTING INC.

PROJECT NUMBER: 15586-023-F PERMIT #:421117

PROJECT NUMBER: 15586-023-E PERMIT #:421117 LOCATION: 515 2ND AVE

SEATTLE, WA 98104


DRAWING NAME: MASTEC - 15586-023-E - PLANS.dwg

CONFIDENTIAL/PROPRIETARY SHEET: 7 OF 27

POLE ELEVATION

NOTES:

- ELEVATION IS DIAGRAMMATIC ONLY.
- NEW EQUIPMENT TO BE PAINTED SHERWIN-WILLIAMS POWDURA TGIC POWDER COATING, DGS2-40003, RAILROAD GREE, RF TRANSPARENT, UV RESISTANT, OUTDOOR RATED PAINT.
- INSTALL RF WARNING SIGNS PER MANUFACTURER SPECIFICATIONS.
- CONTRACTOR SHALL RE-INSTALL ALL EXISTING SIGNAGE AND APPURTENANCES ONTO PROPOSED POLE AS REQUIRED.
- NEW STREET LIGHT AND ARM COLOR AND FINISH TO MATCH EXISTING STREET LIGHT.
- SEE SHEET 9-12 FOR DETAILED POLE SPECIFICATIONS.
- EXISTING BRONZE BASE. CONTRACTOR TO COORDINATE WITH SDOT YARD STORAGE FOR FUTURE USE.

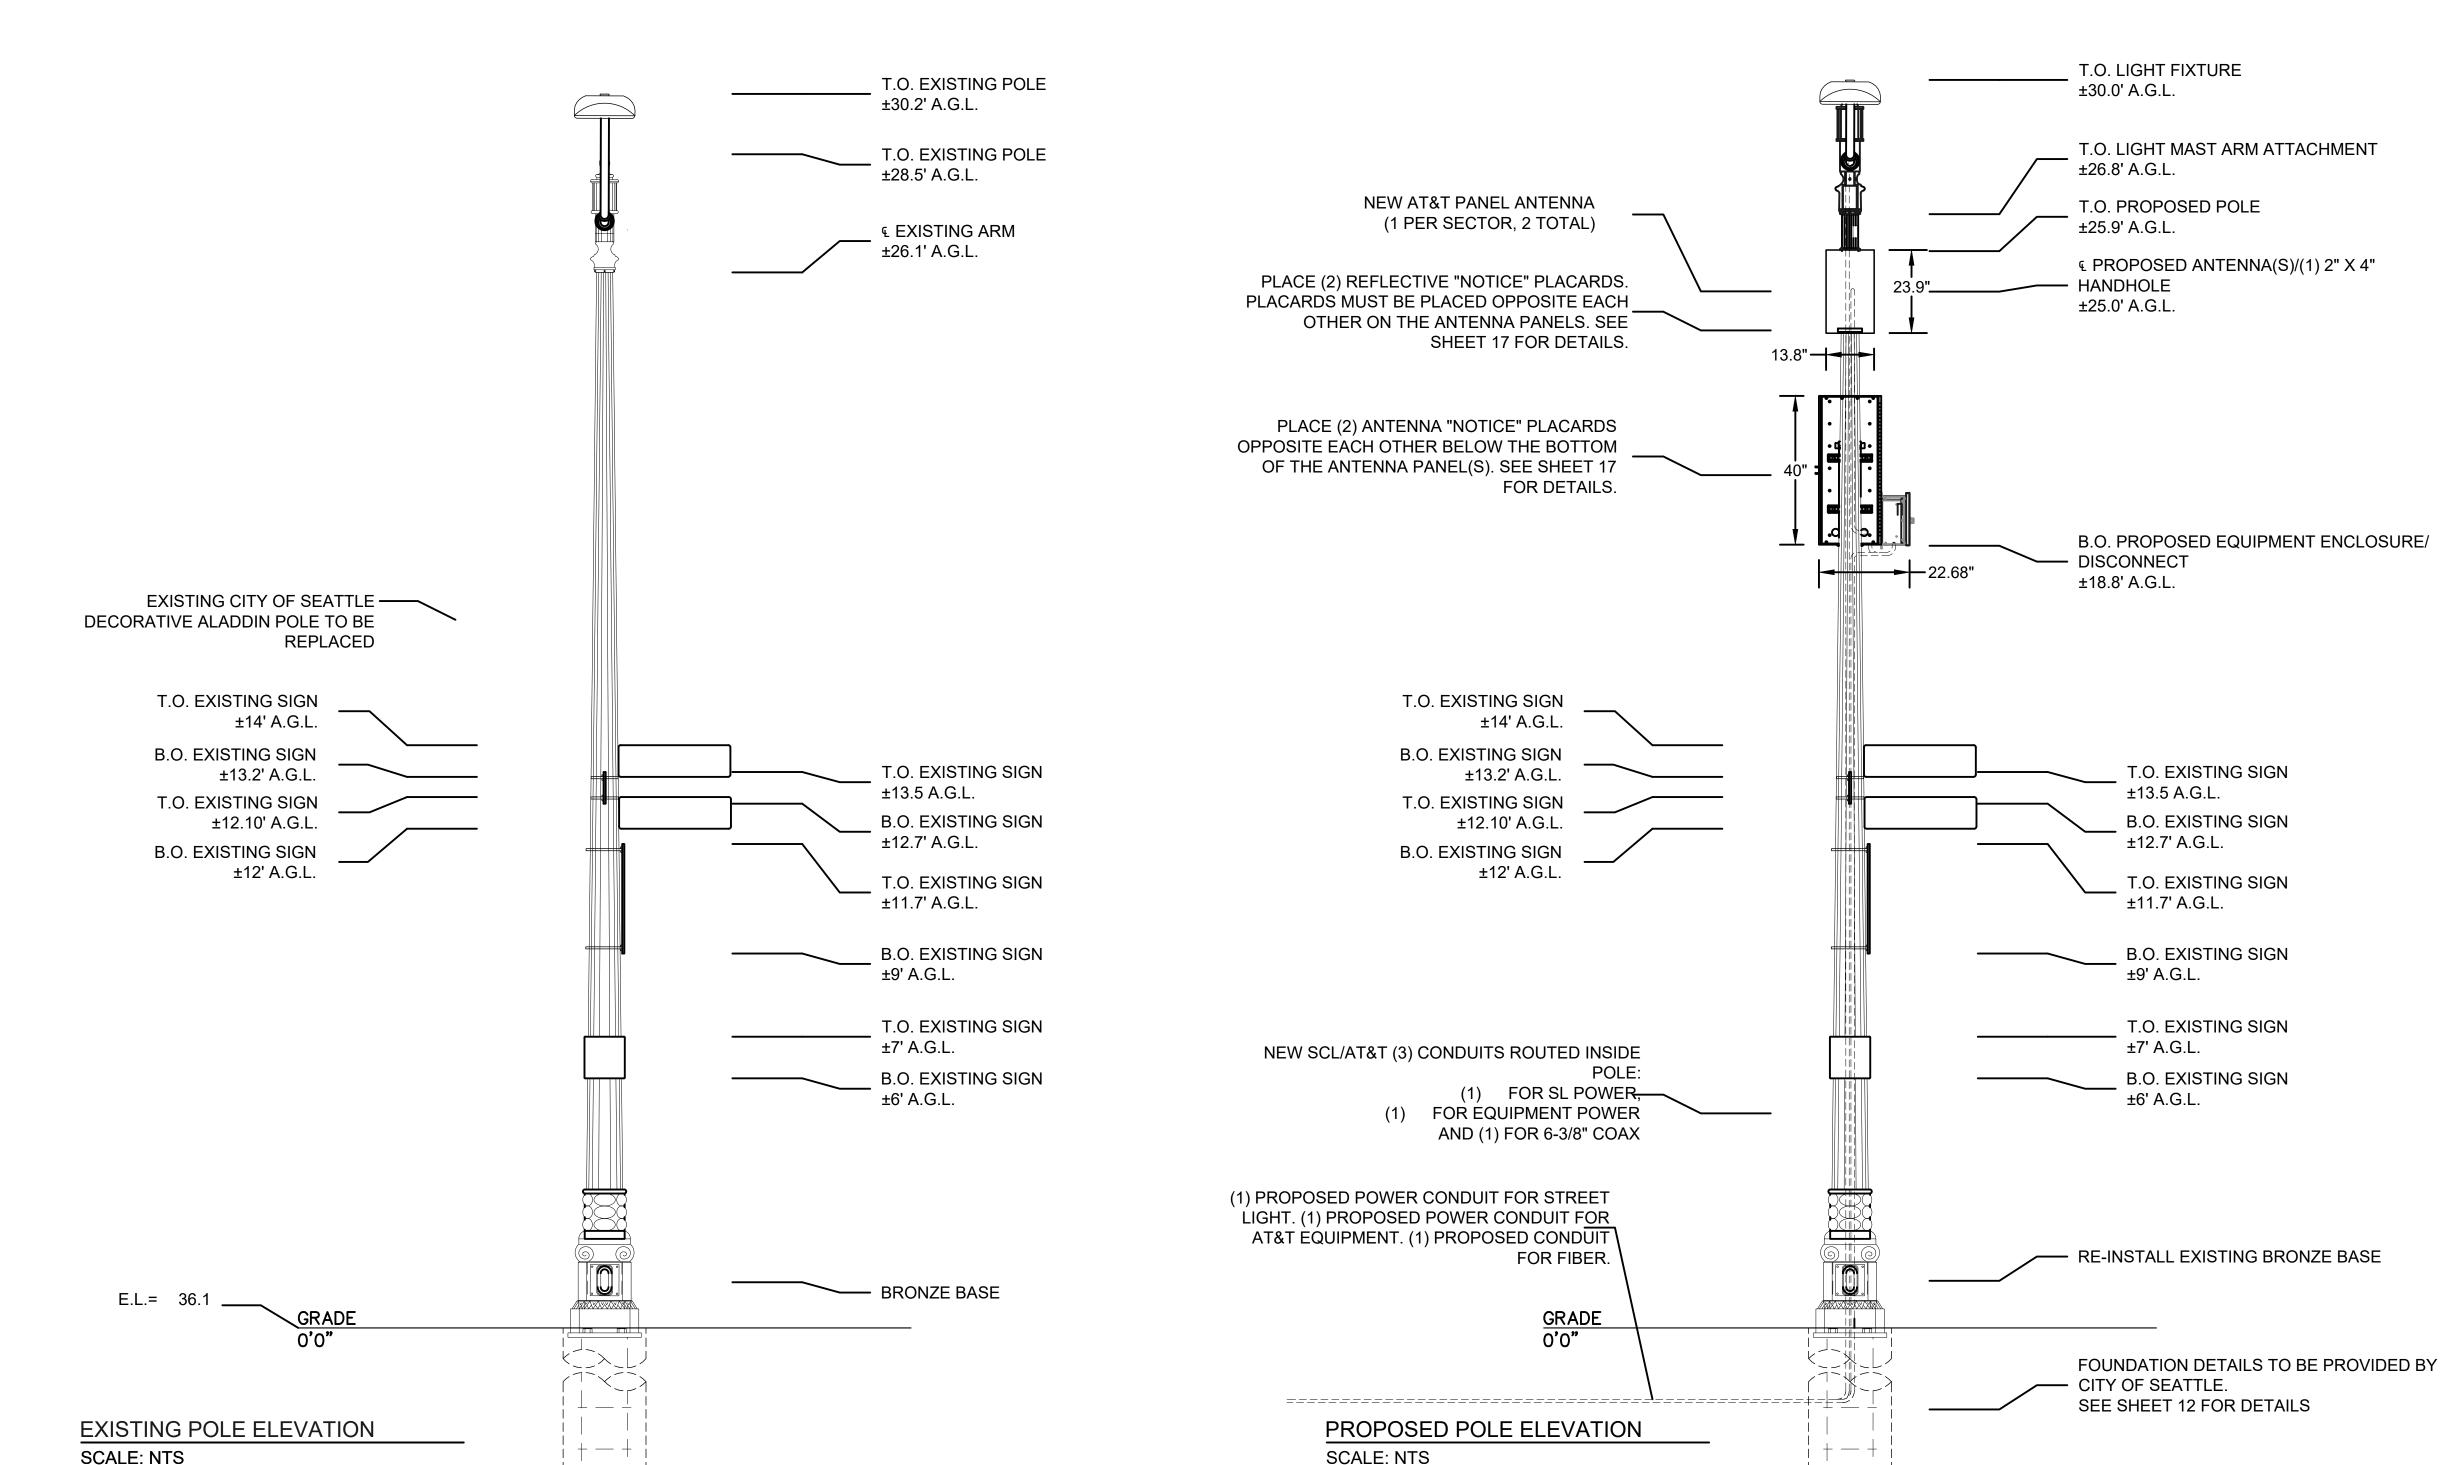

FACING: SOUTHWEST

FACING: SOUTHWEST



PROJECT ENGINEER STAMP

3				AS-BUILT
2	2/17/21	KW	KAW	REVISION # 4
1	3/23/20	MF	DDS	ORIGINAL
NO.	DATE	ENGINEER	DRAFTER	COMMENT





CLIENT PROJECT MANAGER: GIN VILANTE

DRAWING NAME: MASTEC - 15586-023-E - PLANS.dwg

ENGINEERING FIRM: MGC TECHNICAL CONSULTING INC. PROJECT NUMBER: 15586-023-E PERMIT #:421117 LOCATION: 515 2ND AVE

SEATTLE, WA 98104

CONFIDENTIAL/PROPRIETARY SHEET: 8 OF 27

TOP OF LIGHT FIXTURE

TOP OF LIGHT MAST ARM ATTACHEMENT ELEV. 26'-8" AGL

ALADDIN MAST ARM & COBRAL LIGHT PER

BA-AI0303T3T3VJX65F-06

LEGEND

COMBINER - CBC1923Q-43_E14F559P12

MAST ARM & COBRA LIGHT PER SCL SPEC.

EQUIPMENT ENCLOSURE SSC-76023614

MOUNT BRACKET - TS-PM-3545

DESCRIPTION

TOP SCL

HANDHOLE

RRU B46

RRU B66

RRU B2/B25

36020018 - SPLITTER

CLEARFIELD - FDP-XWB1

RSCAC-9457-HP-120

SCL SPEC.

ELEV. 30'-0" AGL

TOP OF POLE

ELEV. 25'-11" AGL

C.L OF ANTENNA ELEV. 25'-0" AGL

C.L. OF 2"X4" HANDHOLE
ELEV. 25'-0" AGL

C.L. OF 3"X5" HANDHOLE

ELEV. 23'-6" & 23'-0" AGL

C.L. OF 3"X5" HANDHOLE

ELEV. 18'-7" & 17'-3" AGL

ELEV. 18'-10" AGL

FESTOON OUTLET BOX ELEV. 18'-0" AGL

C.L. OF 4"X6" HANDHOLE

ELEV. 14'-3" AGL

C.L. OF 3"X5" HANDHOLE

ELEV. 20'-6" & 19'-2" AGL

(1)(2)(3)

BOTTOM OF PROPOSED AT&T ENCLOSURE

BOTTOM OF PROPOSED AT&T DISCONNECT ELEV. 18'-10" AGL

ALL AT&T LINES TO ENTER AND

SCL CONDUITS TO ENTER ON

EXIT POLE ON AT&T SIDE (NOT SCL SIDEWALK SIDE OF

POLE).


FINISH GRADE

ELEV. 0'-0" AGL

PROPOSED POLE ELEVATION

SIDE WALK SIDE.


TAPERED POLE —

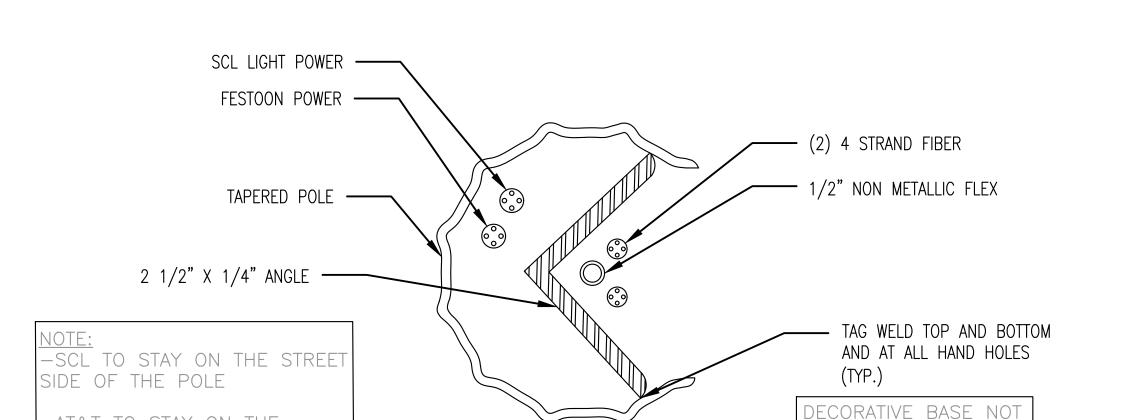

SECTION 'B-B' AT 18'-10" (LOWER SECTION)

-AT&T TO STAY ON THE

SIDEWALK SIDE OF THE POLE

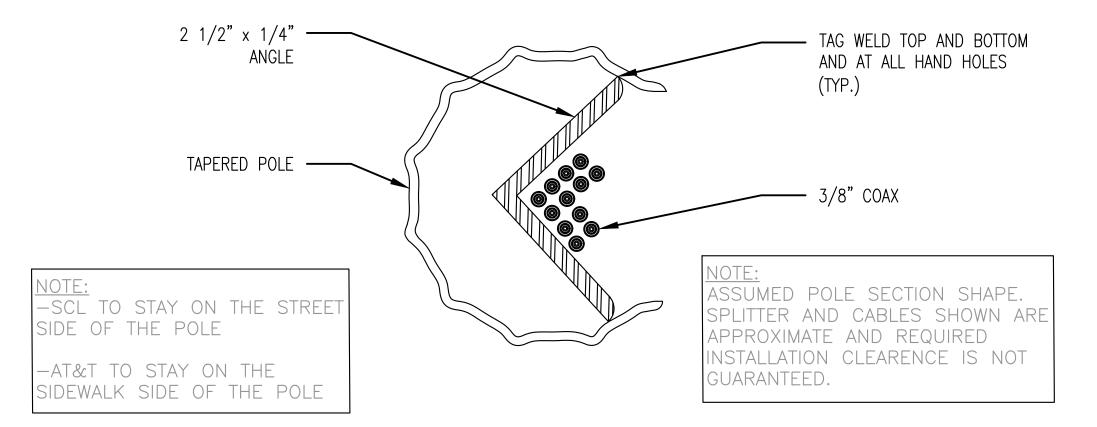

SECTION 'A-A' AT 18'-10" (UPPER SECTION) 2.5" SCH 40 — (4) SET SCREWS 1/4"X4.5"0.DX3"ID -4" SCH 40 — 1" POLE TOP PLATE -ALADDIN ARM PER 0 SCL SPEC (4) 5/16" \emptyset SS BOLTS (1-1/2" LONG) W/LOCK POLE AT BOTTOM COLLAR WAHSERS. TAP HOLES IN ALADDIN BOTTOM 4-5/8"ø OD COLLOR (FIELD DRILL HOLES IN POLE) POLE PER PALN

SHOWN FOR CLARITY.

ALADDIN ATTACHMENT

CONSTRUCTION NOTES

* COORDINATE WITH SCL-STREETLIGHT CREW. REMOVE EXISTING STREET LIGHT AND REPLACE WITH NEW SCL-AND SDOT-APPROVED DECORATIVE CHIEF SEATTLE STYLE STREET LIGHT. FOR POLE DELIVERY, SEE GENERAL NOTES FOR DETAILS. COORDINATE WITH SDOT AND KING COUNTY METRO FOR SIGNAGE REMOVAL AND REPLACEMENT ON NEW POLE.

LETS AMERICA, INC POLE DESIGN

REFERENCE ATTACHED PDF (~SEA Aladdin Street Lights-CSB - NoExceptionsApproval - 3.16.20) FOR ENGINEERING STAMP AND APPROVAL.

PROJECT ENGINEER STAMP

_				, ,,, ,,,,,,,,,,,,,,,,,,,,,,,,,,,,,,,,,				
2	2/17/21	KW	KAW	REVISION # 4				
1	3/23/20	MF	DDS	ORIGINAL				
NO.	DATE	ENGINEER	DRAFTER	COMMENT				
•	*MasTec Network Solutions MGE TECHNICAL CONSULTING INC							
CLIENT PROJECT MANAGER: GIN VILANTE								
EN	GINEERING	FIRM: MGC	TECHNICAL	CONSULTING INC.				
PRO	OJECT NUM	BER: 15586	-023-E PERM	/IT #:421117				
LO	CATION: 515	2ND AVE						
	SE	ATTLE, WA 9	98104					

SHEET: 9 OF 27

DRAWING NAME: MASTEC - 15586-023-E - PLANS.dwg

CONFIDENTIAL/PROPRIETARY

Know what's below.
Call before you dig.

SECTION AT SCL PORT

TOP OF POLE INSIDE COLLAR ELEV. 26'-0" AGL

BA-AI0303T3T3VJX65F-06

ITEM #

RRU B46

RRU B66

TAPERED POLE

RRU B2/B25

86020018 - SPLITTER

CLEARFIELD - FDP-XWB1

RSCAC-9457-HP-120

LEGEND

COMBINER - CBC1923Q-43_E14F559P12

EQUIPMENT ENCLOSURE SSC-76023614

MOUNT BRACKET - TS-PM-3545

DESCRIPTION

C.L. OF 2"X4" HANDHOLE ELEV. 25'-0" AGL

C.L. OF 3"X5" HANDHOLE

ELEV. 23'-6" & 23'-0" AGL

C.L. OF 3"X5" HANDHOLE

ELEV. 20'-6" & 19'-2" AGL

FESTOON OUTLET BOX
ELEV. 18'-0" AGL

C.L. OF 3"X5" HANDHOLE 4 5 6

ELEV. 18'-7" & 17'-3" AGL

BOTTOM OF PROPOSED AT&T ENCLOSURE
ELEV. 18'-10" AGL

BOTTOM OF PROPOSED AT&T DISCONNECT ELEV. 18'-10" AGL

ALL AT&T LINES TO ENTER AND EXIT POLE ON AT&T SIDE (NOT SCL SIDEWALK SIDE OF POLE.

C.L. OF 4"X6" HANDHOLE


ELEV. 1'-0" AGL

FINISH GRADE

ELEV. 0'-0" AGL

PROPOSED POLE ELEVATION

C.L. OF ANTENNA ELEV. 24'-0" AGL

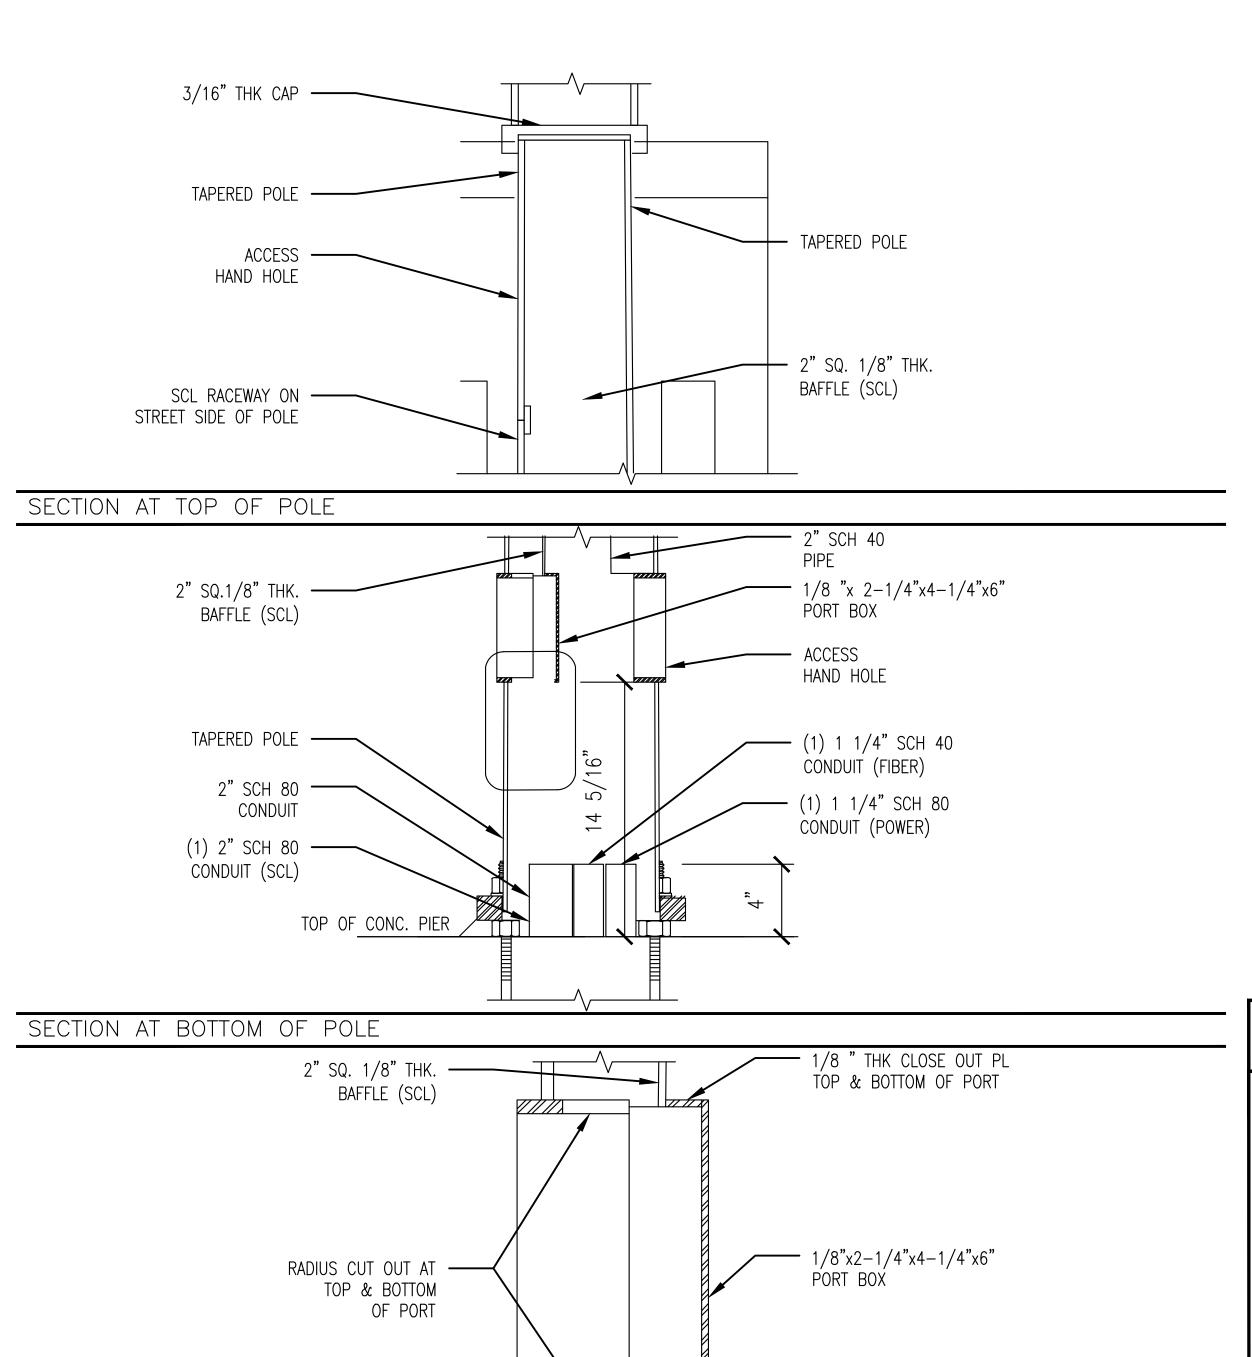

CONSTRUCTION NOTES

* COORDINATE WITH SCL-STREETLIGHT CREW. REMOVE AND SDOT-APPROVED DECORATIVE CHIEF SEATTLE STYLE STREET LIGHT. FOR POLE DELIVERY, SEE GENERAL NOTES FOR DETAILS. COORDINATE WITH SDOT AND KING COUNTY METRO FOR SIGNAGE REMOVAL AND REPLACEMENT ON NEW POLE.

LETS AMERICA, INC POLE DESIGN

REFERENCE ATTACHED PDF (~SEA Aladdin Street Lights-CSB - NoExceptionsApproval - 3.16.20) FOR ENGINEERING STAMP AND APPROVAL.

PROJECT ENGINEER STAMP

NO.	DATE	ENGINEER	DRAFTER	COMMENT
1	3/23/20	MF	DDS	ORIGINAL
2	2/17/21	KW	KAW	REVISION # 4
3				AS-BUILT





SHEET: 10 OF 27

CLIENT PROJECT MANAGER: GIN VILANTE

ENGINEERING FIRM: MGC TECHNICAL CONSULTING INC. PROJECT NUMBER: 15586-023-E PERMIT #:421117

LOCATION: 515 2ND AVE SEATTLE, WA 98104

DRAWING NAME: MASTEC - 15586-023-E - PLANS.dwg

CONFIDENTIAL/PROPRIETARY


Know what's below.

Call before you dig.

(4) 1-1/8"ø HOLE ON 15-3/4" B.C. 1" V-NOTCH AT 3/16" THIK A36 ø1'-0 3/4"ID Ø1'-3 3/4"BC

CONSTRUCTION NOTES


* COORDINATE WITH SCL-STREETLIGHT CREW. REMOVE AND SDOT-APPROVED DECORATIVE CHIEF SEATTLE STYLE STREET LIGHT. FOR POLE DELIVERY, SEE GENERAL NOTES FOR DETAILS. COORDINATE WITH SDOT AND KING COUNTY METRO FOR SIGNAGE REMOVAL AND REPLACEMENT ON NEW POLE.

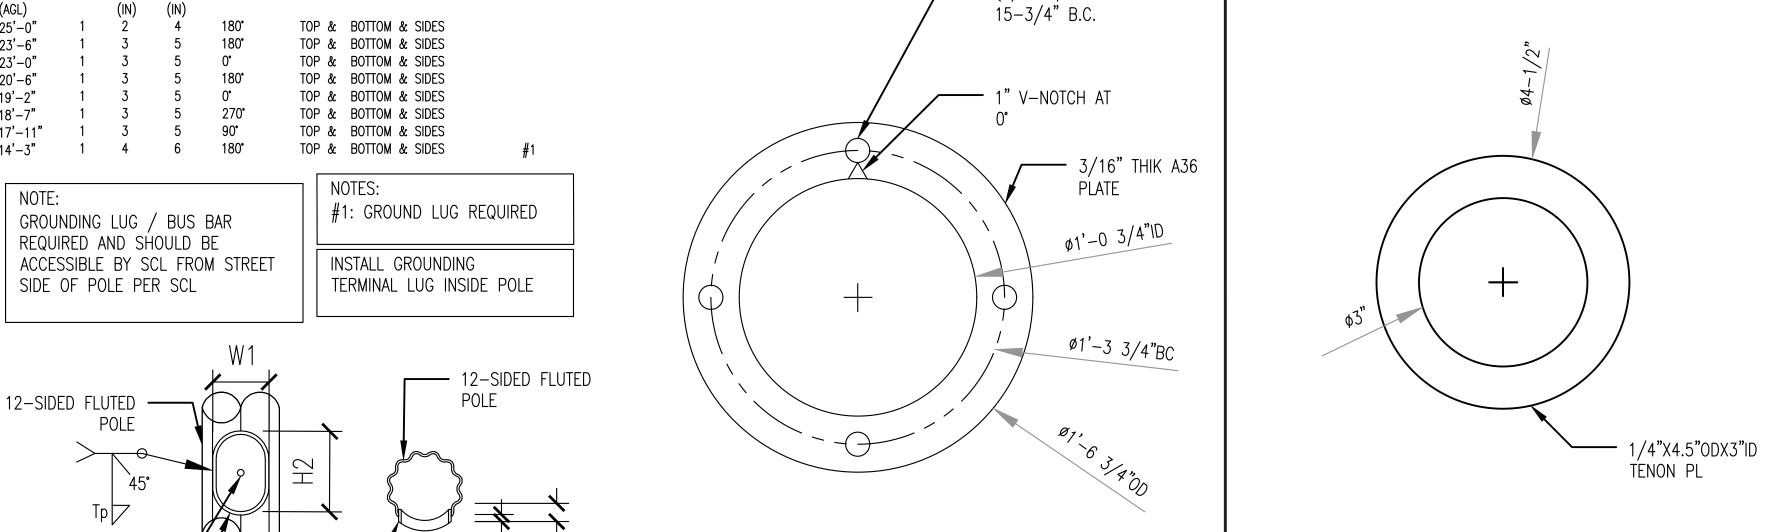

ANCHOR BOLT TEMPLATE BASE PLATE UPPER REINFORCED HANDHOLE DETAIL 1/4"X4.5"ODX3"ID TENON PL

D2

UNREINFORCED HAND/ACCESS HOLE SCHEDULE

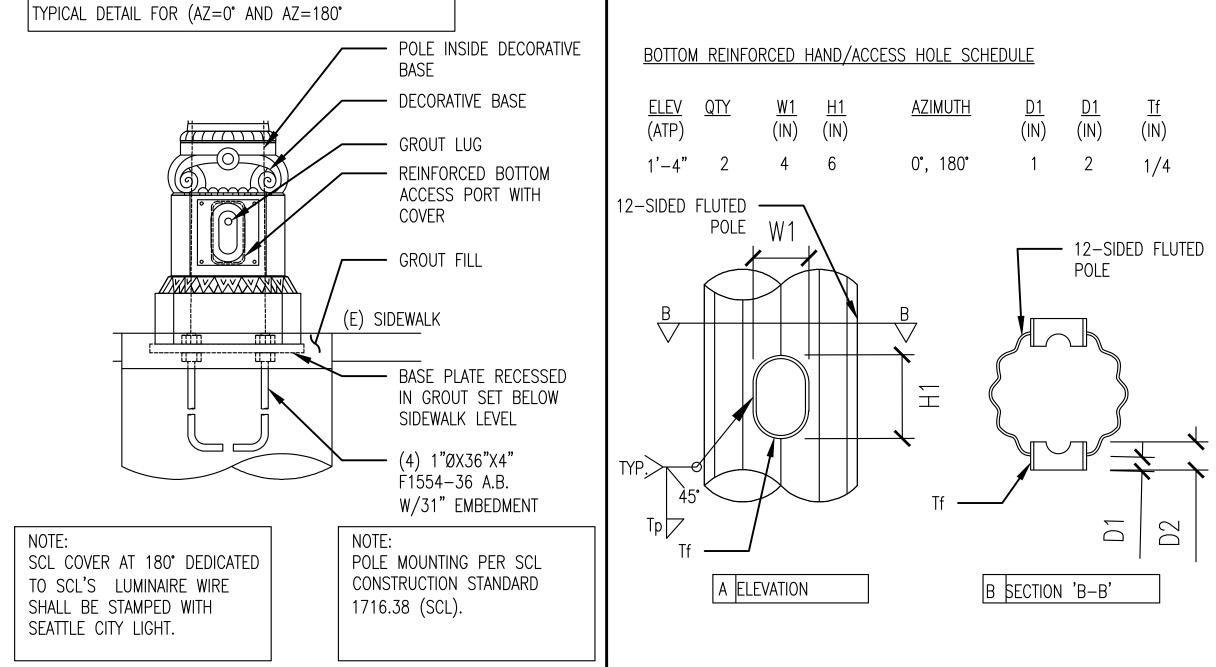

(NOTE #1)

REINFORCED HANDHOLE DETAIL


15 3/4"

CIRCLE


DIAMÉTER BOLT

3'-0"

BASE DETAIL (AZ=0° AND AZ=180°)

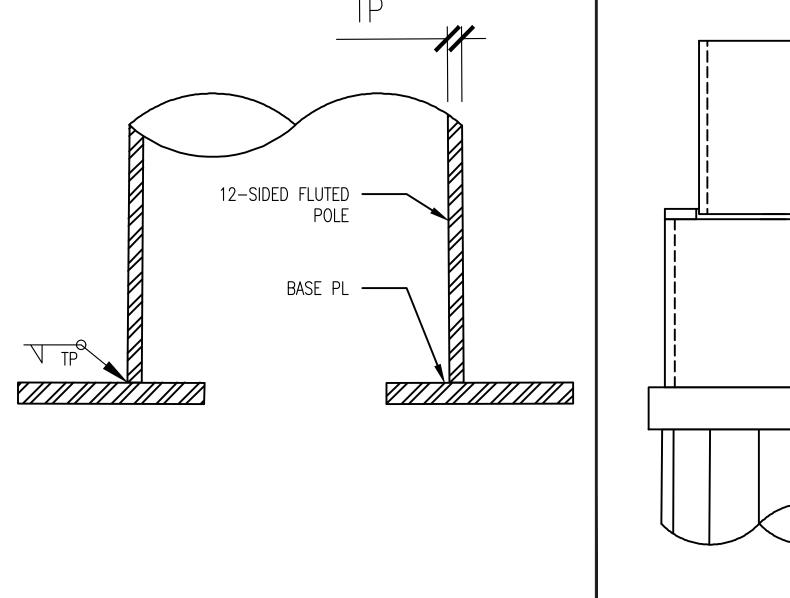

POLE TO BASE PL WELD

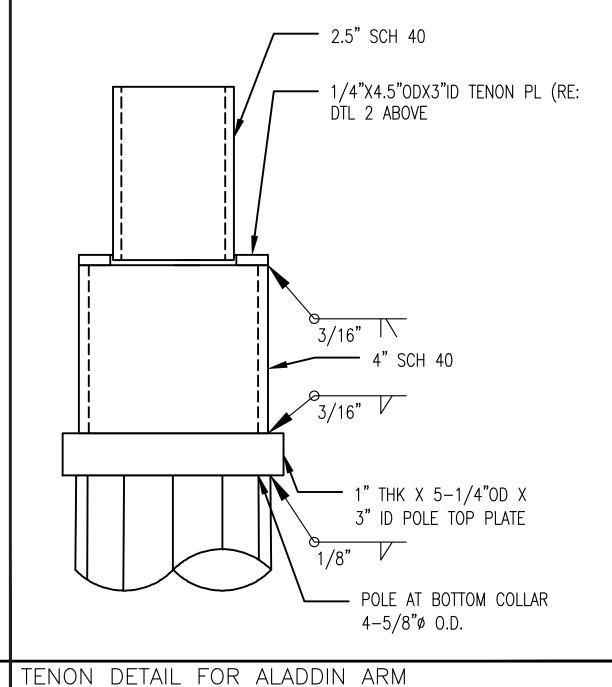

LETS AMERICA, INC POLE DESIGN

REFERENCE ATTACHED PDF (~SEA Aladdin Street Lights-CSB - NoExceptionsApproval - 3.16.20) FOR ENGINEERING STAMP AND APPROVAL.

PROJECT ENGINEER STAMP

3				AS-BUILT
2	2/17/21	KW	KAW	REVISION # 4
1	3/23/20	MF	DDS	ORIGINAL
NO.	DATE	ENGINEER	DRAFTER	COMMENT
3	Ma	ST	ec	MGE




Network Solutions CLIENT PROJECT MANAGER: GIN VILANTE **ENGINEERING FIRM: MGC TECHNICAL CONSULTING INC. PROJECT NUMBER**: 15586-023-E PERMIT #:421117

LOCATION: 515 2ND AVE SEATTLE, WA 98104

DRAWING NAME: MASTEC - 15586-023-E - PLANS.dwg

CONFIDENTIAL/PROPRIETARY SHEET: 11 OF 27


POLE WALL

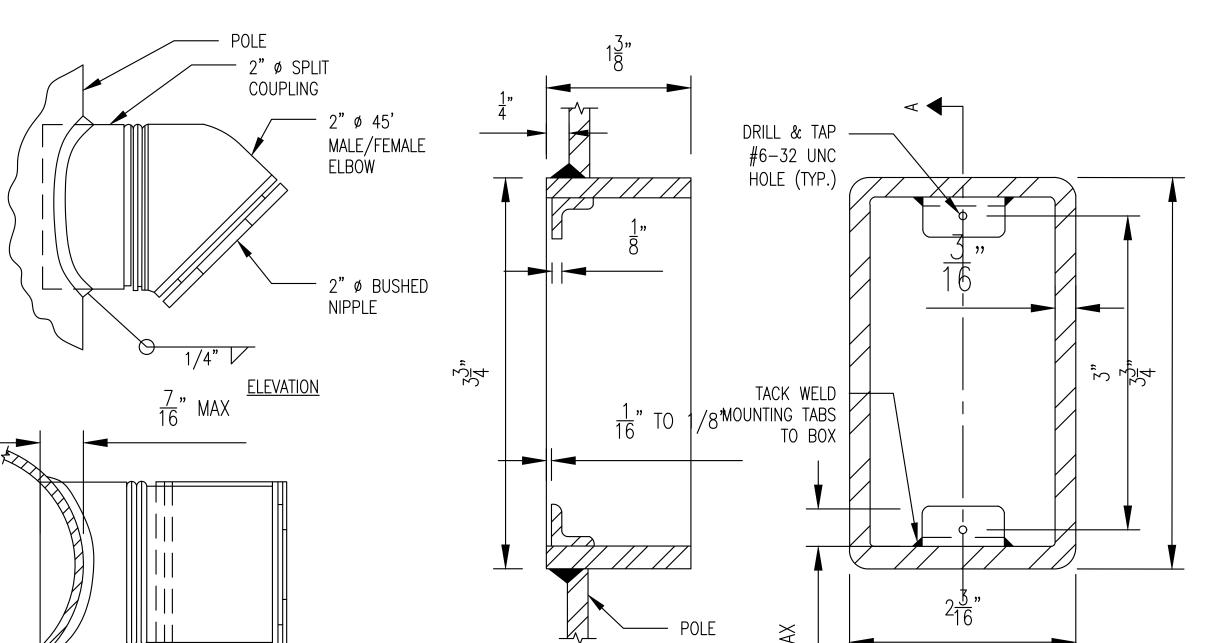

1/2"

CONSTRUCTION NOTES

* COORDINATE WITH SCL-STREETLIGHT CREW. REMOVE AND SDOT-APPROVED DECORATIVE CHIEF SEATTLE STYLE STREET LIGHT. FOR POLE DELIVERY, SEE GENERAL NOTES FOR DETAILS. COORDINATE WITH SDOT AND KING COUNTY METRO FOR SIGNAGE REMOVAL AND REPLACEMENT ON NEW POLE.

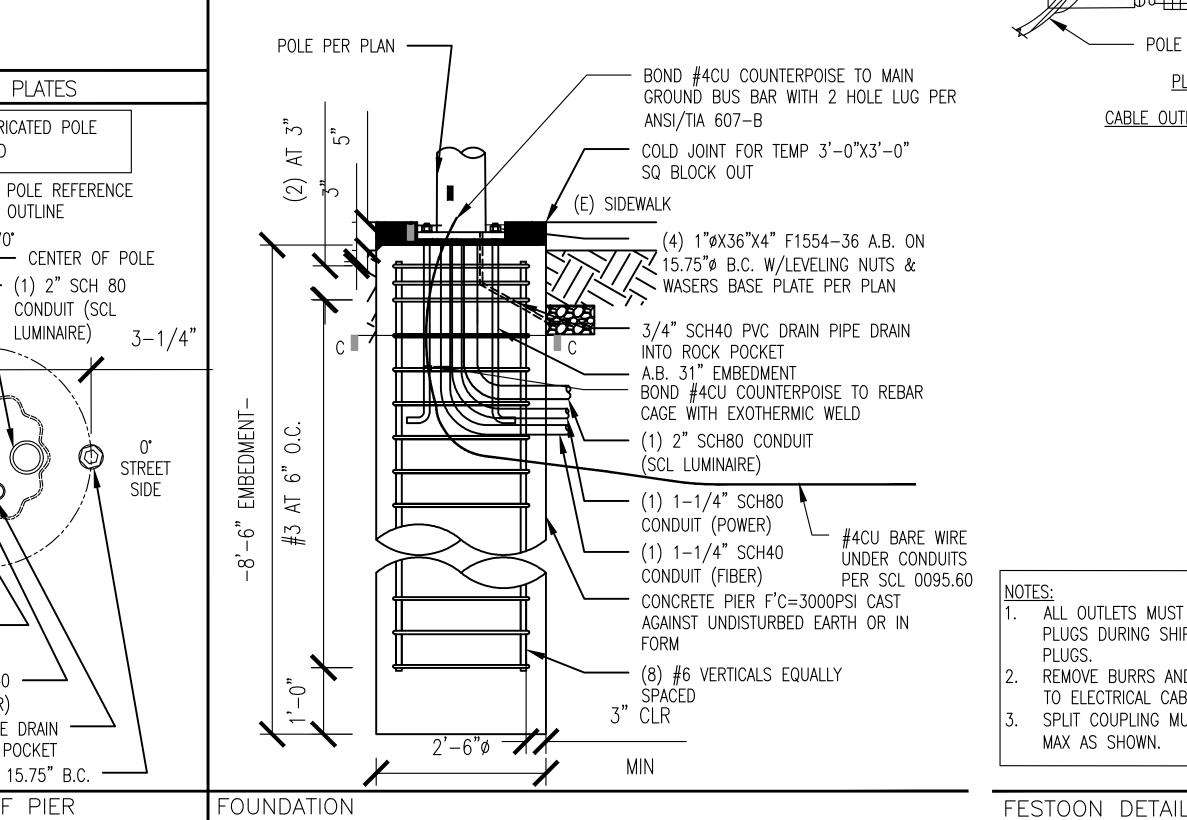

SECTION 'C-C'

MIN. 12" TIE

STREET SIDE

STREET

SIDE

(4) 1"øX36"X4" F1554-36 A.B. ON 15.75" B.C. W/LEVELING NUTS & WASERS BASE PLATE PER PLAN

SCL CONDUITS ON

OVERLAP

AT&T POWER & FIBER ----CONDUITS ON THE

SIDEWALK SIDE

#3 TIES —

SIDEWALK

SIDE

(8) #5 BARS EQUALLY

STEEL PLATE

FABRICATOR

—— POLE

POLE REFERENCE

CENTER OF POLE

CONDUIT (SCL

STREET SIDE

(1) 2" SCH 80

OUTLINE

DEMARC/RAYCAP MOUNT PLATES

3-3/8"

SIDEWALK SIDE

(1) 1-1/4" SCH 80 -

CONDUIT (POWER)

(1) 1-1/4" SCH 40 —

CONDUIT (FIBR)

INTO ROCK POCKET

A.B. ON 15.75" B.C. —

3/4" SCH40 PVC DRAIN PIPE DRAIN

CONDUITS AT TOP OF PIER


*** FIELD VERIFY WITH FABRICATED POLE

PLACE AS REQ'D

STANDOFF MOUNTING

TO BE PROVIDED BY

BRACKETS, DETAILS

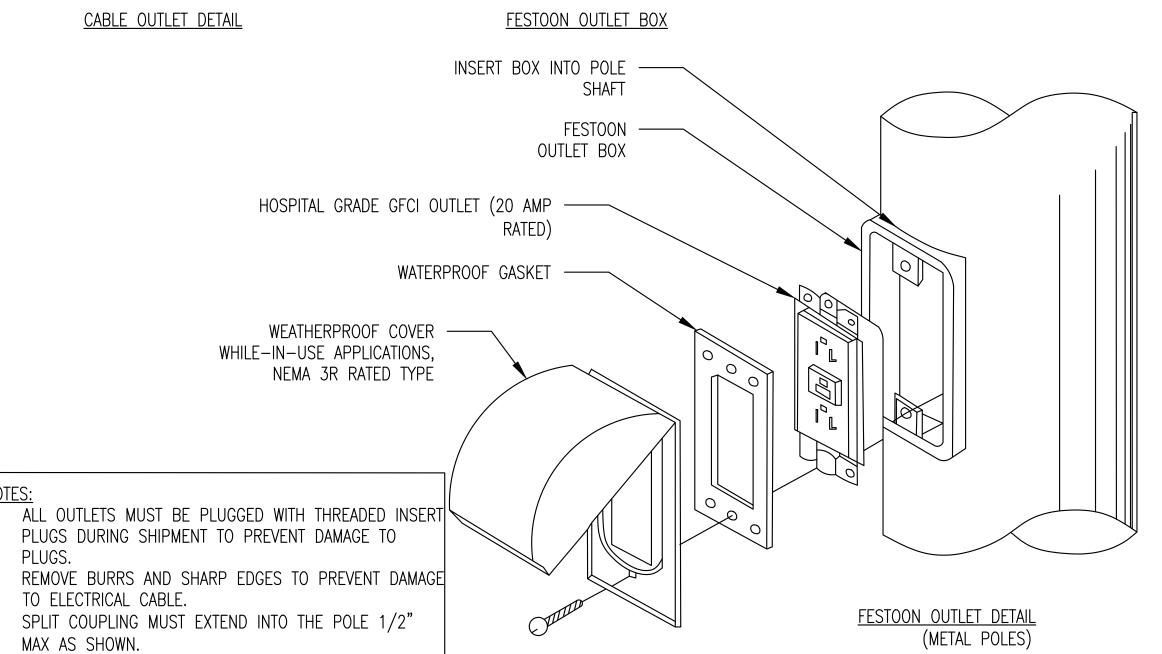

SECTION A-A

REFERENCE ATTACHED PDF (~SEA Aladdin Street Lights-CSB - NoExceptionsApproval - 3.16.20) FOR ENGINEERING STAMP AND APPROVAL.

LETS AMERICA, INC POLE DESIGN

PROJECT ENGINEER STAMP

<u> </u>	DAIL	LITOINELIX	DIVILIN	OOMMEN1
NO.	DATE	ENGINEER	DRAFTER	COMMENT
1	3/23/20	MF	DDS	ORIGINAL
2	2/17/21	KW	KAW	REVISION # 4
3				AS-BUILT





CLIENT PROJECT MANAGER: GIN VILANTE

ENGINEERING FIRM: MGC TECHNICAL CONSULTING INC. PROJECT NUMBER: 15586-023-E PERMIT #:421117

LOCATION: 515 2ND AVE SEATTLE, WA 98104


DRAWING NAME: MASTEC - 15586-023-E - PLANS.dwg

CONFIDENTIAL/PROPRIETARY SHEET: 12 OF 27


Know what's below.

Call before you dig.

EQUIPMENT DETAILS

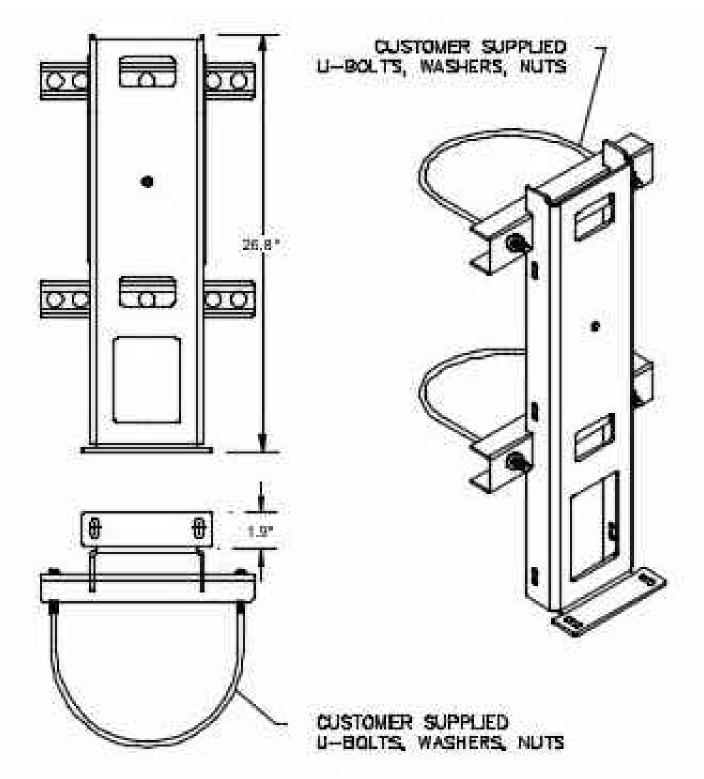

ROSENBERGER-BA-AIO3O3T3T3VJX65F-O6 SMALL/MICRO PANEL ANTENNA (3G/4G/5G)

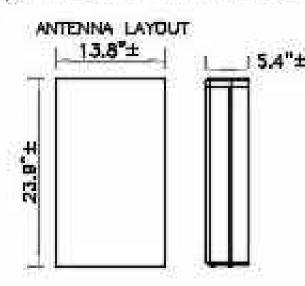

LAYOUT OF INTERFACE (BOTTOM VIEW)


NOTE:
PLACE THREE AT&T 1"X6" NOTICE
STICKERS EQUALLY SPACED AT OR
NEAR THE BOTTOM ANTENNA.

ANTENNA DETAIL

SCALE: NTS


UNIVERSAL POLE MOUNT KIT DETAIL


SCALE: NTS:

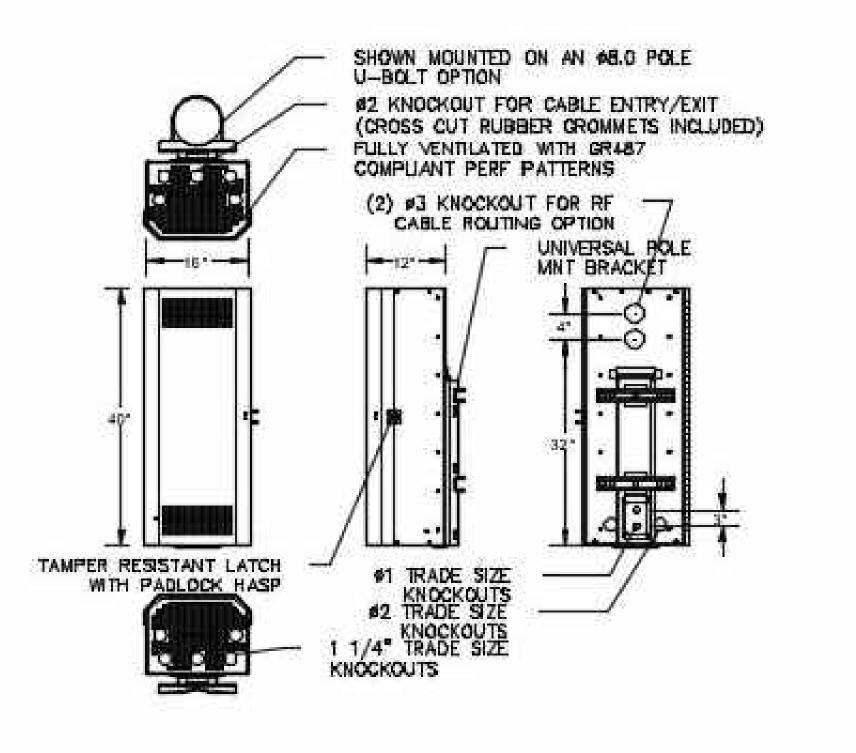


PICO EQUIPMENT ENCLOSURE DETAIL

SCALE: NTS

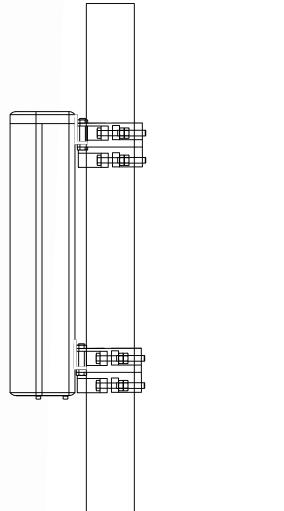

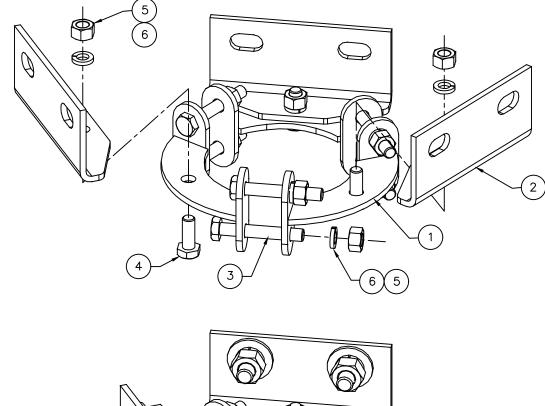


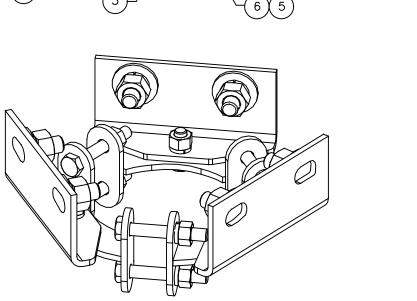

				PAF	RTS LIST	SHIP WT ≈ 1	10.2 LBS
ITEM #	SHIP QTY	SHIP MARK	PC MARK	PC QTY	DESCRIPTION	LENGTH	REMARKS
1	6	TS-PM-3545-1		_	沒 CLAMP WELDMENT	0'-57/16"	
2	6	TS-PM-3545-2		-	MOUNT PIPE ADAPTER $(2\frac{3}{6})^{2}-2\frac{7}{6}$ 0.D.)	0'-57/16"	FORMED
		HARD	WARE				
3	_		BG-38-225	12	ϕ_8^3 "x2 $\frac{1}{4}$ " GALV. GR.5 BOLT		
4	_		BG-38-125	18	$\phi \frac{3}{8}$ "x1 $\frac{1}{4}$ " GALV. GR.5 BOLT		
5	_		NG-38	18	ø³⁄g" GALV. NUT		
6	_		WLG-38	18	ø¾" GALV. LOCK WASHER		

RADIO MOUNT MOUNT DETAIL

SCALE: NTS

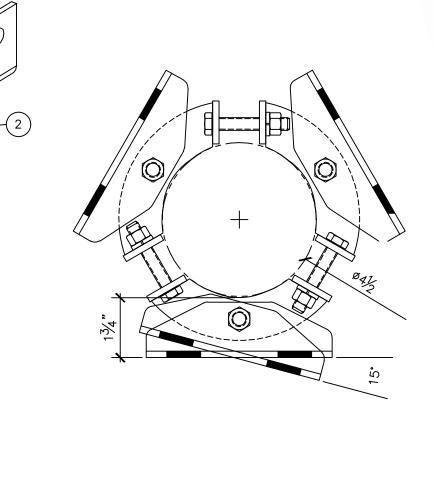



PROJECT	ENGINEER	STAMP

3				AS-BUILT
2	2/17/21	KW	KAW	REVISION # 4
1	3/23/20	MF	DDS	ORIGINAL
NO.	DATE	ENGINEER	DRAFTER	COMMENT





CLIENT PROJECT MANAGER: GIN VILANTE **ENGINEERING FIRM: MGC TECHNICAL CONSULTING INC.**

PROJECT NUMBER: 15586-023-E PERMIT #:421117 LOCATION: 515 2ND AVE


SEATTLE, WA 98104


DRAWING NAME: MASTEC - 15586-023-E - PLANS.dwg

CONFIDENTIAL/PROPRIETARY

SHEET: 13 OF 27


EQUIPMENT DETAILS

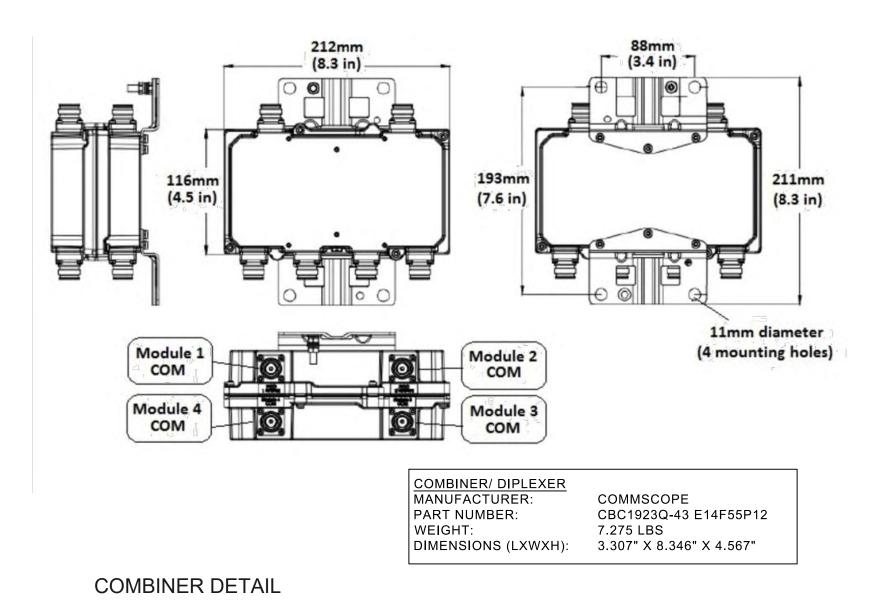

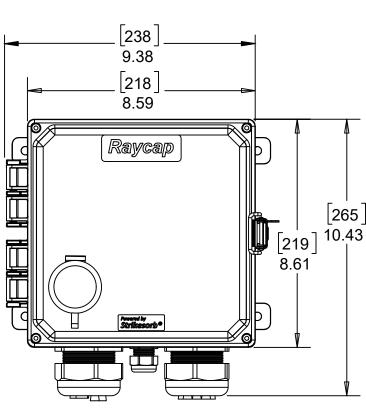


SCALE: NTS

AC DISCONNECT/SURGE PROTECTOR DETAIL

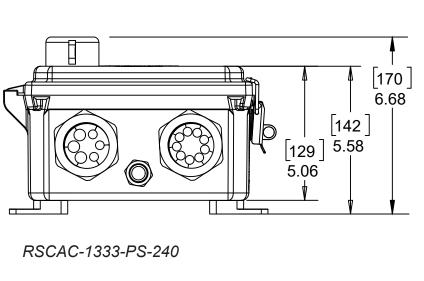


DIMENSIONS (LXWXH): 8.59" X 9.46" X 10.43"

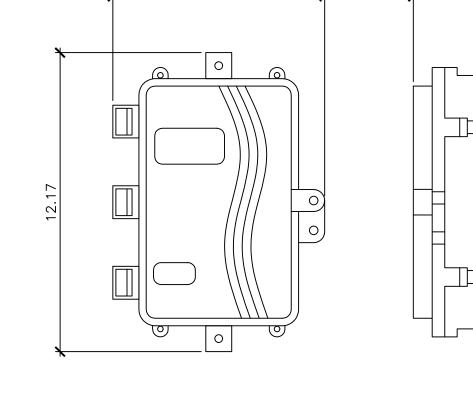


MANUFACTURER: FIELDSMART FIBER DELIVERY POINT (FDP)
MODEL: FDP-xWB1 | FDP-xAK1
HEIGHT: 12.17"
WIDTH: 8.62"
DEPTH: 3.91"

FIBER DELIVERY POINT DETAIL


SCALE: NTS

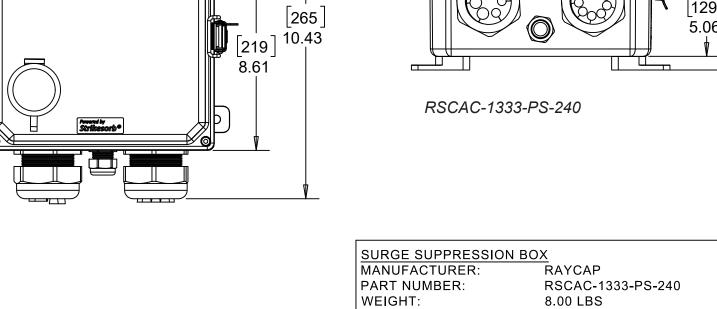





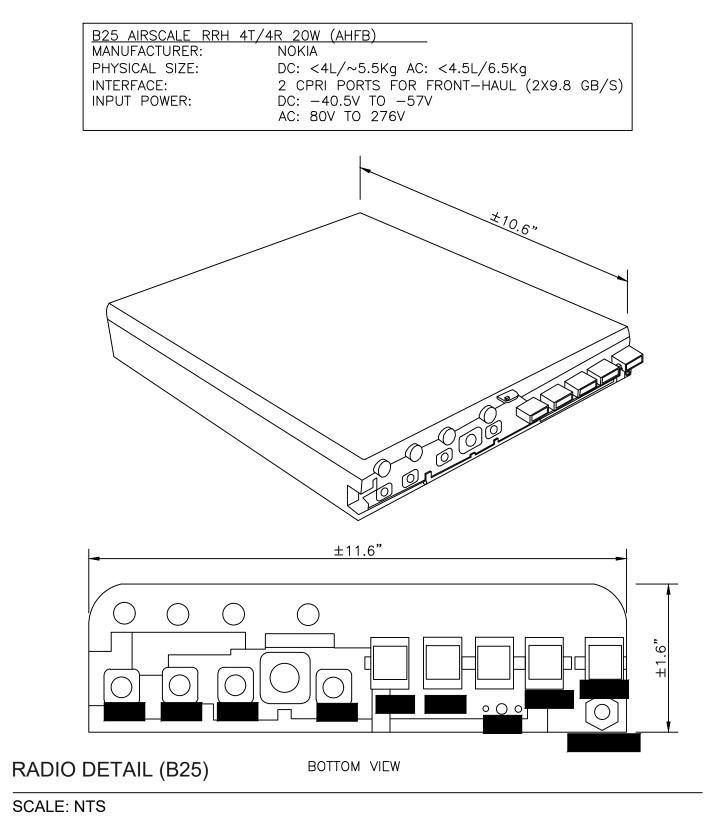

SCALE: NTS

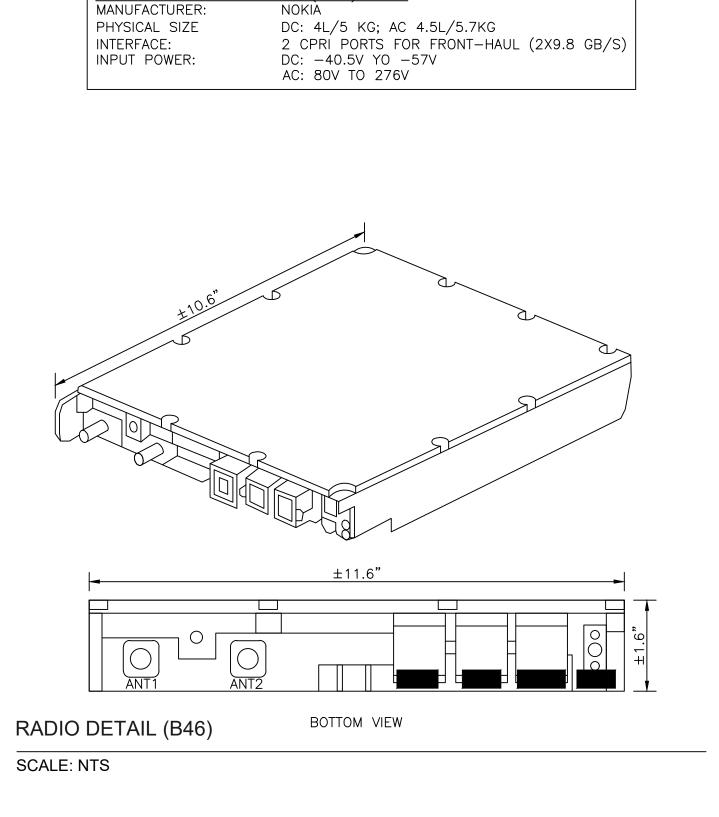


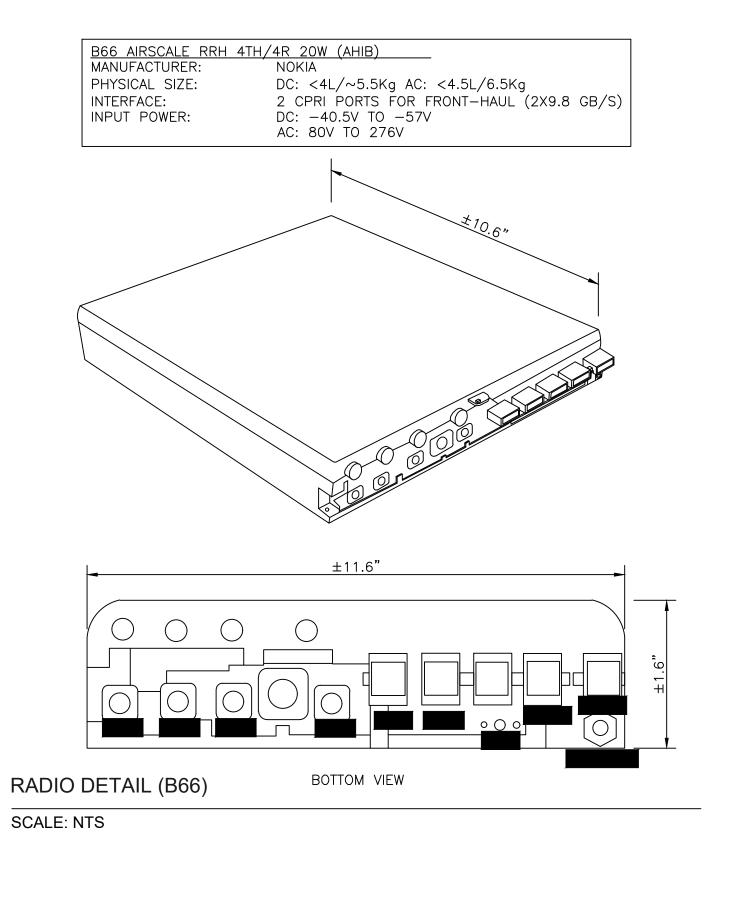


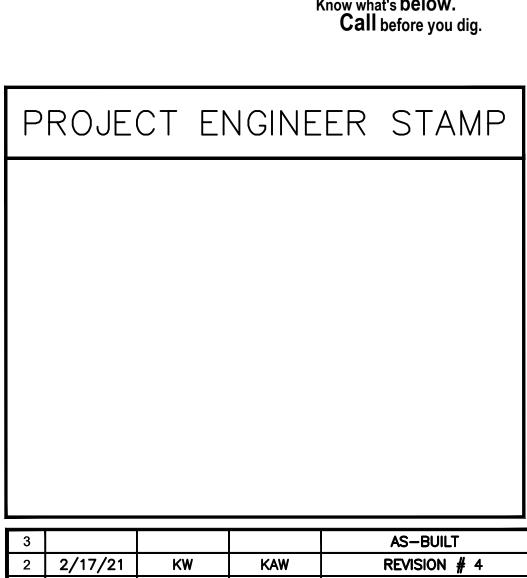

3				AS-BUILT		
2	2/17/21	KW	KAW	REVISION # 4		
1	3/23/20	MF	DDS	ORIGINAL		
NO.	DATE	ENGINEER	DRAFTER	COMMENT		
4		ST ork Solu		MGE TECHNICAL CONSULTING INC		
CLII	ENT PROJEC	CT MANAGE	R: GIN VILA	NTE		
ENG	SINEERING	FIRM: MGC	TECHNICAL	CONSULTING INC.		
PRO	DJECT NUM	BER: 15586-	-023-E PERM	IIT #:421117		
LOC	LOCATION: 515 2ND AVE SEATTLE, WA 98104					
DRA	AWING NAM	E: MASTEC - 1	15586-023-E - P	PLANS.dwg		
COI	NFIDENTIAL	/PROPRIETA	ARY	SHEET: 14 OF 27		


UNDERGROUND DETAILS

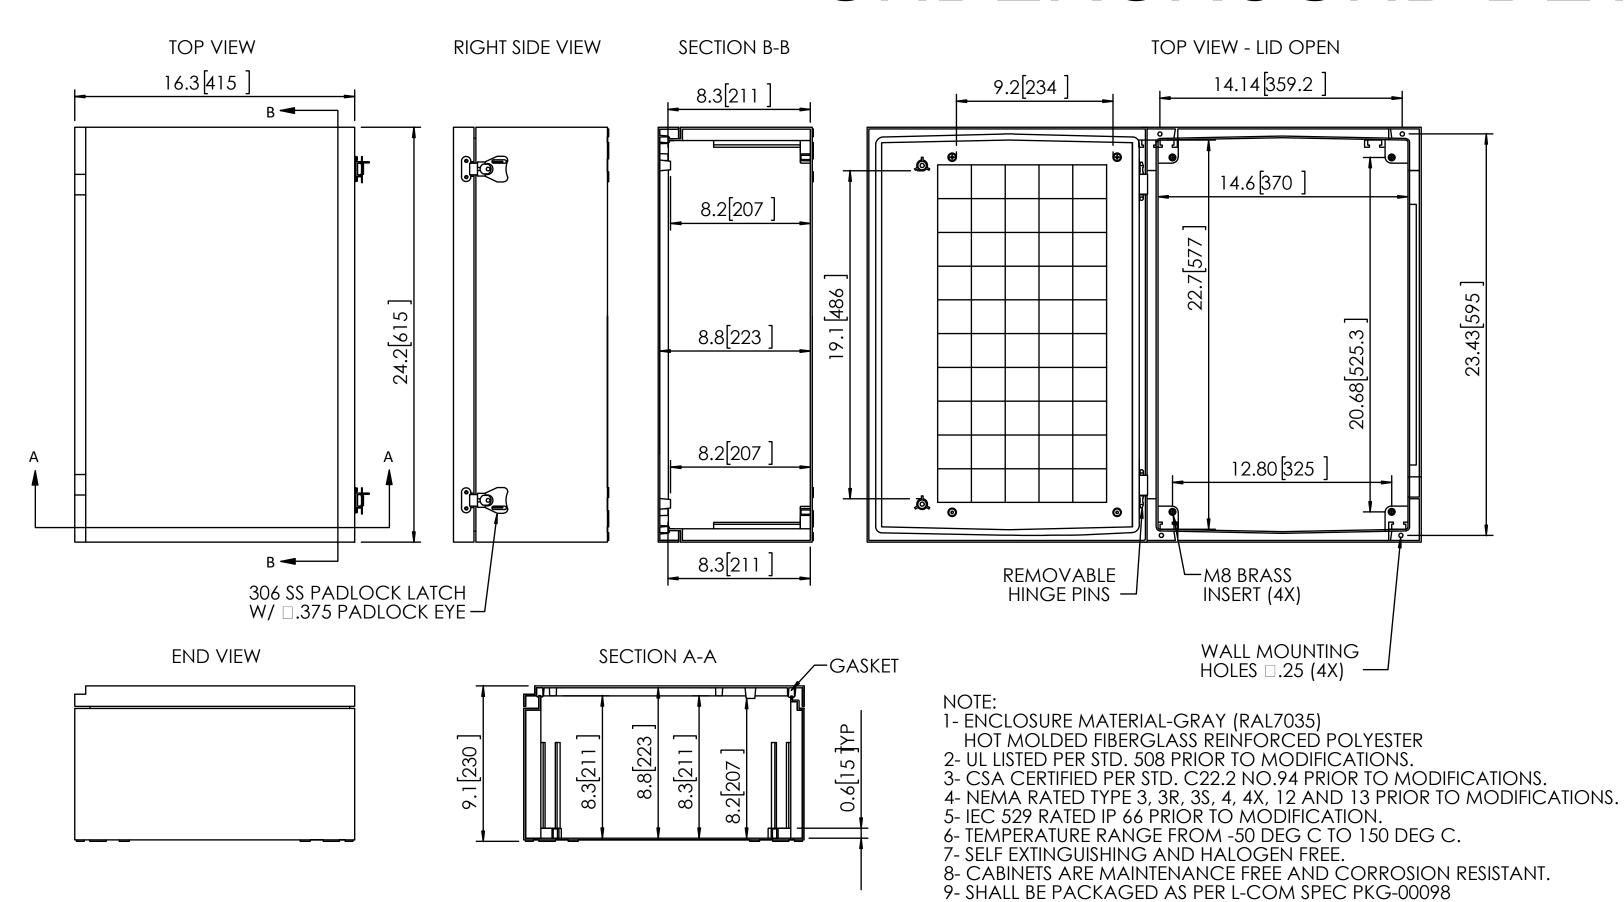

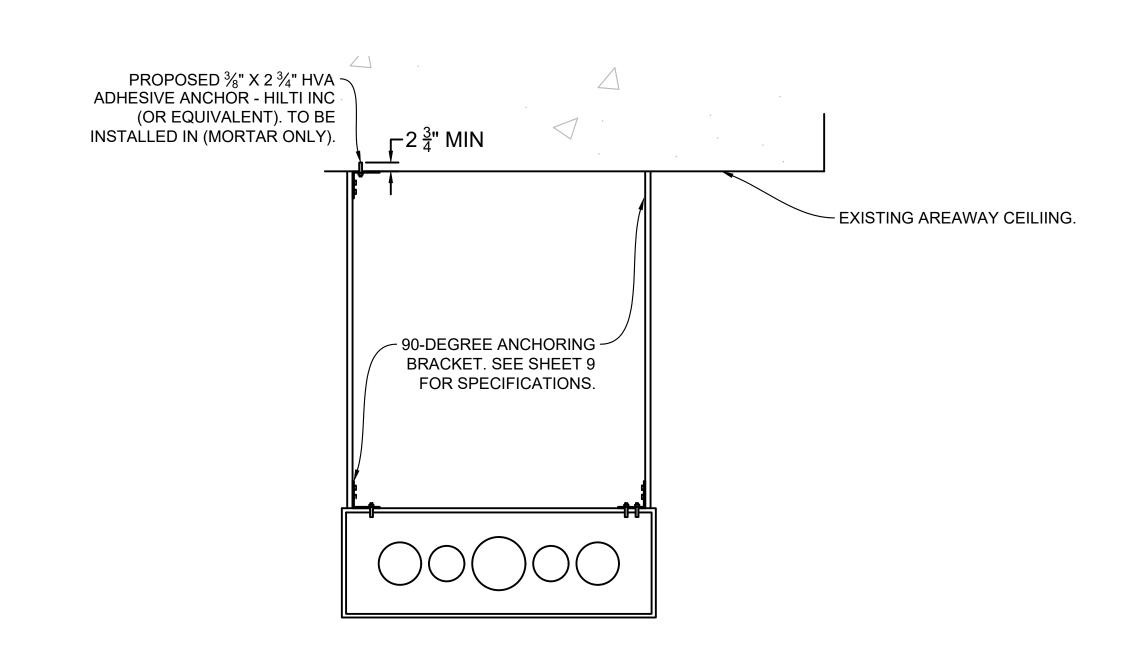

NEMA ENCLOSURE 24 X16 X 9 DETAIL


SCALE: NTS

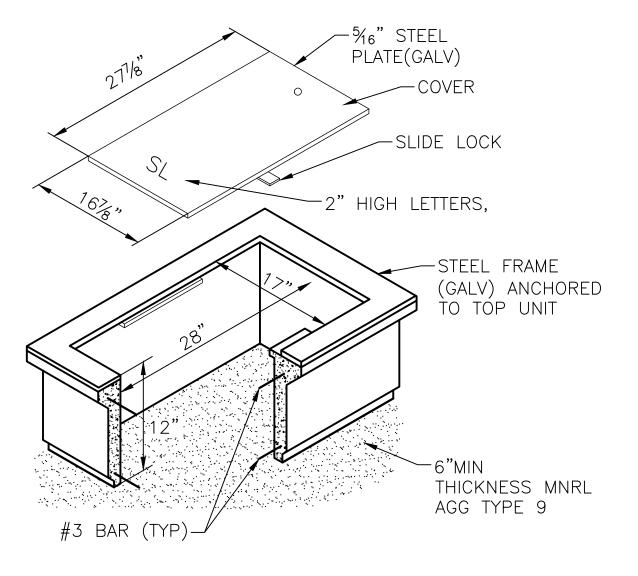

* HANDHOLE SHALL COMPLY WITH COS STANDARD PLAN 550 A — TYPE 2.

TYPE 2 HANDHOLE DETAIL

SCALE: NTS

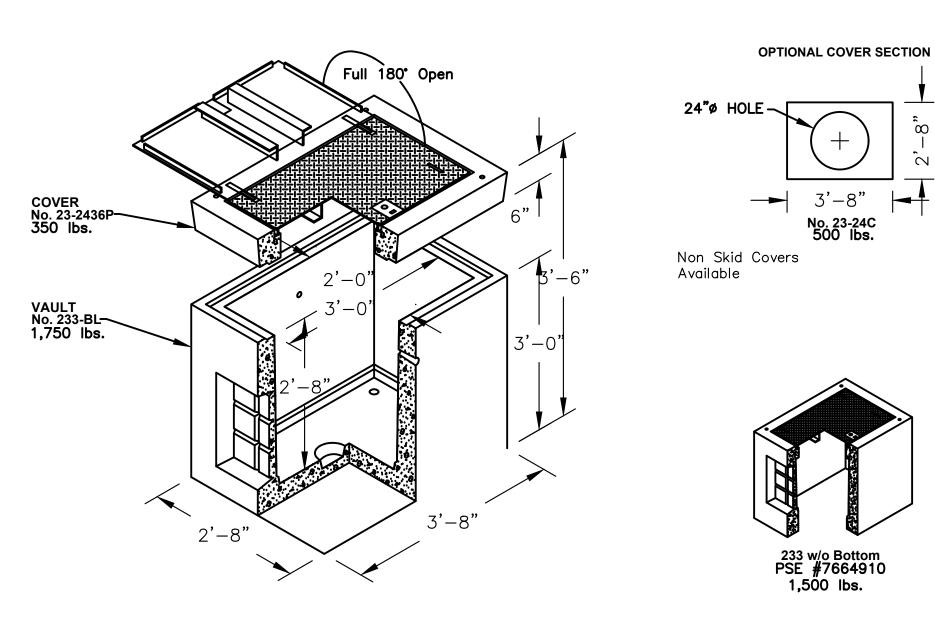


233LA HANDHOLE DETAIL

SCALE: NTS



SCALE: NTS

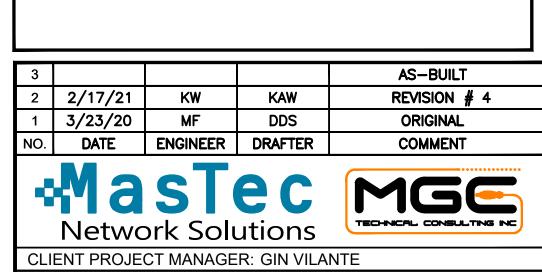

PROJECT ENGINEER STAMP



Network Solutions	TECHNICAL CONSULTING INC
CLIENT PROJECT MANAGER: GIN VILANT	E
ENGINEERING FIRM: MGC TECHNICAL C	ONSULTING INC.
PROJECT NUMBER: 15586-023-E PERMIT	#:421117
LOCATION: 515 2ND AVE	
SEATTLE, WA 98104	
DRAWING NAME: MASTEC - 15586-023-E - PLA	NS.dwg

CONFIDENTIAL/PROPRIETARY SHEET: 15 OF 27

SITE PHOTOGRAPHS

PHOTO #1: FACING NE IN THE MIDDLE OF YESLER WAY

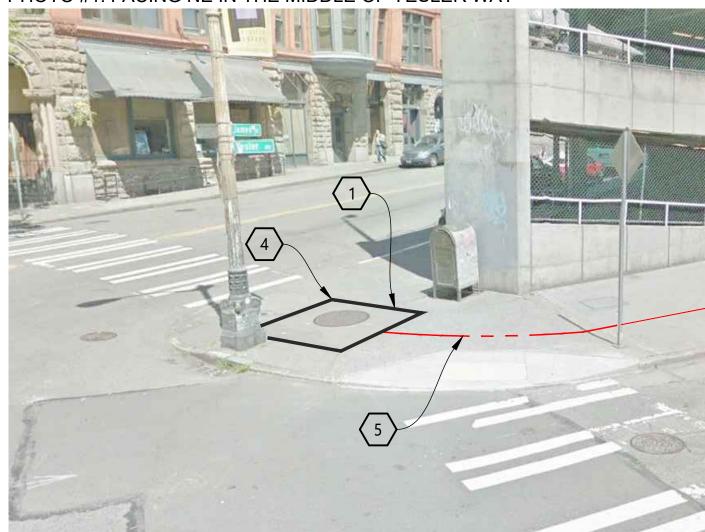


PHOTO #2: FACING EAST ON NORTH SIDE OF YESSLER WAY

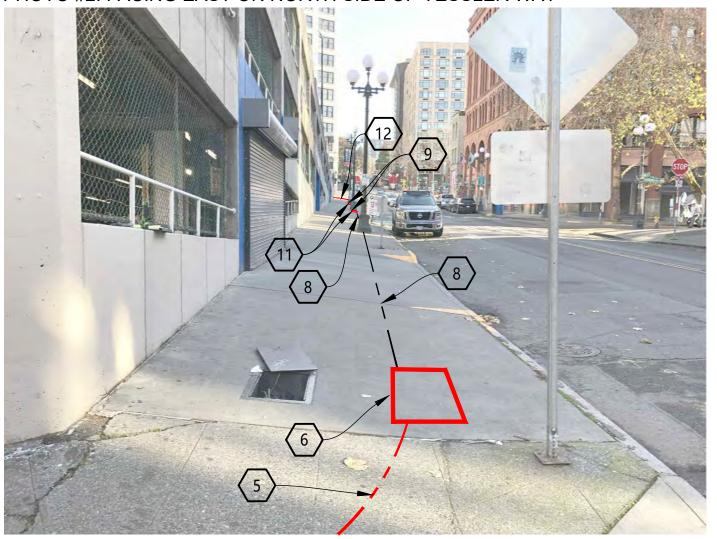


PHOTO #3: FACING WEST IN AREAWAY



PHOTO #4: FACING EAST IN AREAWAY



PHOTO #5: FACING WEST IN AREAWAY


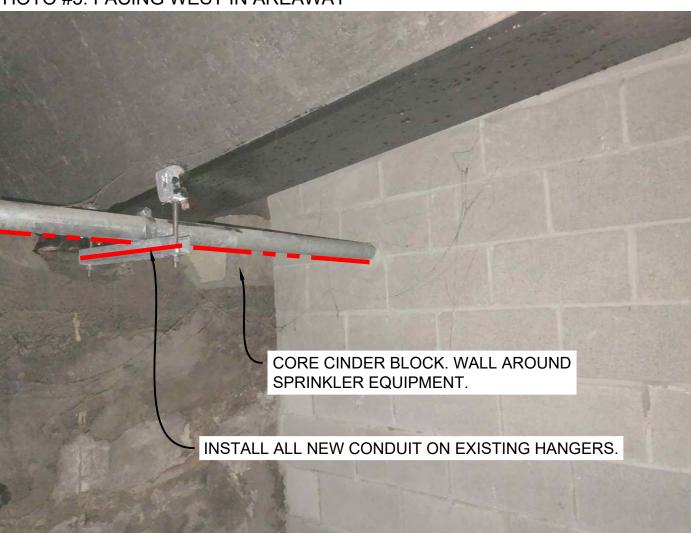


PHOTO #6: FACING EAST IN AREAWAY

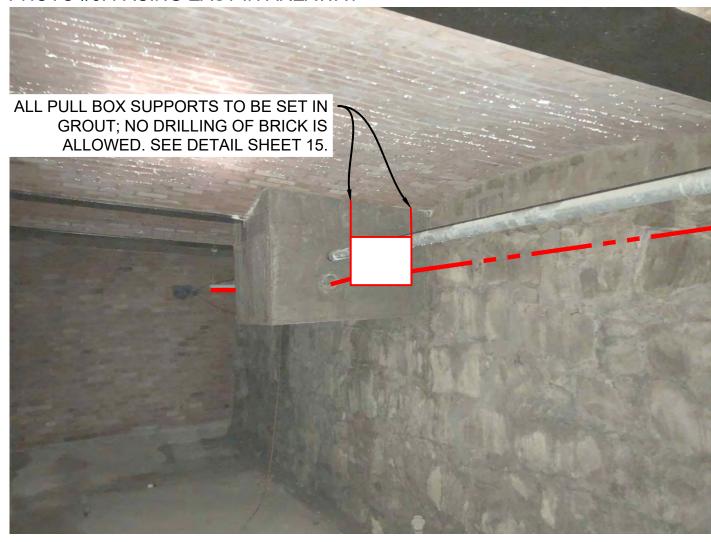

DUOTO #7: EACING EAST IN ADEAMAY

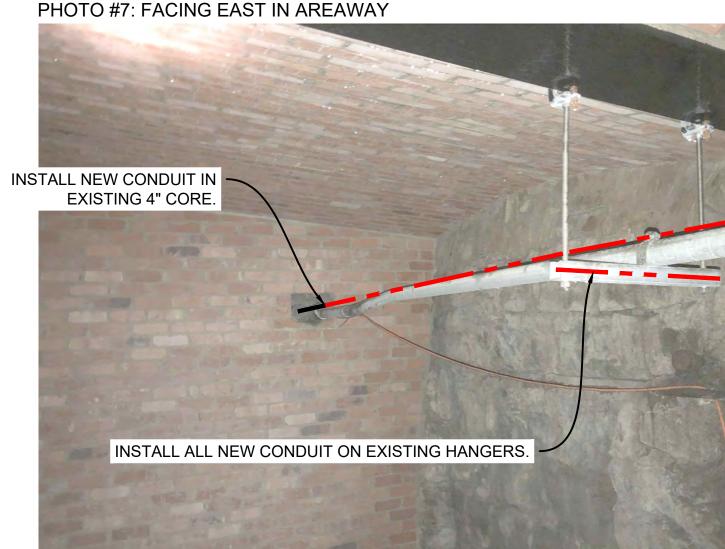


PHOTO #8: FACING WEST IN AREAWAY


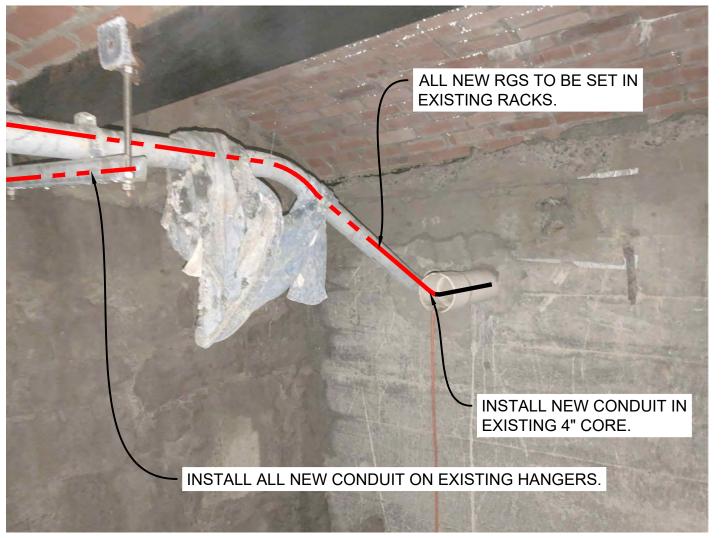


PHOTO #9: FACING EAST IN AREAWAY

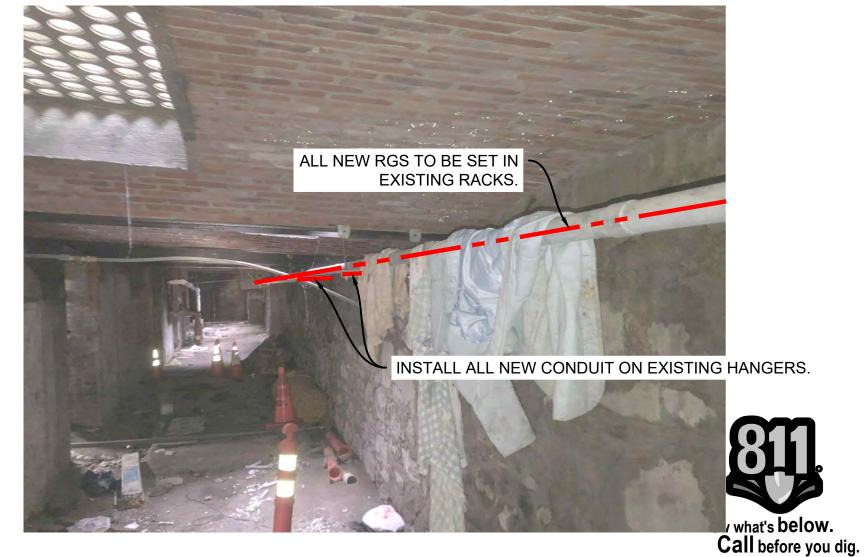

CONSTRUCTION NOTES

- COORDINATE WITH STREETLIGHT CREW FOR SERVICE DISCONNECTION FROM MH 126-M-1 TO ASSET#1313162.
- EXISTING SCL VAULT 126-M-1, CONTRACTOR TO CORE VAULT AND INSTALL CONDUIT PER SCL CONSTRUCTION STANDARD 7020.05.
- CONTRACTOR TO TRENCH AND REMOVE EXISTING
 CONDUIT. INSTALL (2) 3" RGS CONDUIT FROM MH 126-M-1
 TO 126-H-2. INSTALL PER SCL CONSTRUCTION STANDARD
 0095.60 AND 1716.07.
- 6 CONTRACTOR TO REPLACE HH 126-H-2 WITH (1) NEW TYPE-5 SL HH PER COS STD PLAN 550A AND SCL CONSTRUCTION STANDARD 1716.07.
- CONTRACTOR TO INSTALL (1) 3-1/2" RGS CONDUIT FROM EXISTING 3-1/2" RGS TO J-BOX-2. INSTALL PER SCL CONSTRUCTION STANDARDS 0095.60 AND 1716.07.
- PULL THROUGH EXISTING (1) 3-1/2" RGS CONDUIT. FROM NEWLY INSTALLED TYP5 5 HH TO NEWLY INSTALLED 3-1/2" RGS.
- 9 CONTRACTOR TO RE-ROUTE EXISTING CONDUIT FROM POLE BASE TO NEWLY-INSTALLED HH.
- CONTRACTOR TO INSTALL (1) NEW NEMA 4X STAINLESS STEEL J-BOX SIMILAR IN SIZE TO TYPE-2 HH. INTERCEPT EXISTING CONDUIT. MOUNTING OF J-BOX TO BE APPROVED BY STRUCTURAL ENGINEER AND SDOT IN AREA WAY.
- CONTRACTOR TO INSTALL (2) 2" RGS CONDUIT FROM J-BOX-3 TO J-BOX-4. INSTALL PER SCL CONSTRUCTION STANDARD 0095.60 AND 1716.07.

1. EXISTING CONDUIT AND PULL BOXES TO BE BROUGHT UP TO SDOT AND SCL STANDARDS TO MAITAIN AREAWAY.

PROJECT ENGINEER STAMP

3				AS-BUILT
2	2/17/21	KW	KAW	REVISION # 4
1	3/23/20	MF	DDS	ORIGINAL
NO.	DATE	ENGINEER	DRAFTER	COMMENT
٠	Ma Netwo	ST ork Solu		MGE TECHNICAL CONSULTING INC
CLI	ENT PROJE	CT MANAGE	R: GIN VILA	NTE

ENGINEERING FIRM: MGC TECHNICAL CONSULTING INC.
PROJECT NUMBER: 15586-023-E PERMIT #:421117

LOCATION: 515 2ND AVE SEATTLE, WA 98104

DRAWING NAME: MASTEC - 15586-023-E - PLANS.dwg

CONFIDENTIAL/PROPRIETARY SHEET: 16 OF 27

SITE PHOTOGRAPHS

PHOTO #10: FACING EAST IN AREAWAY

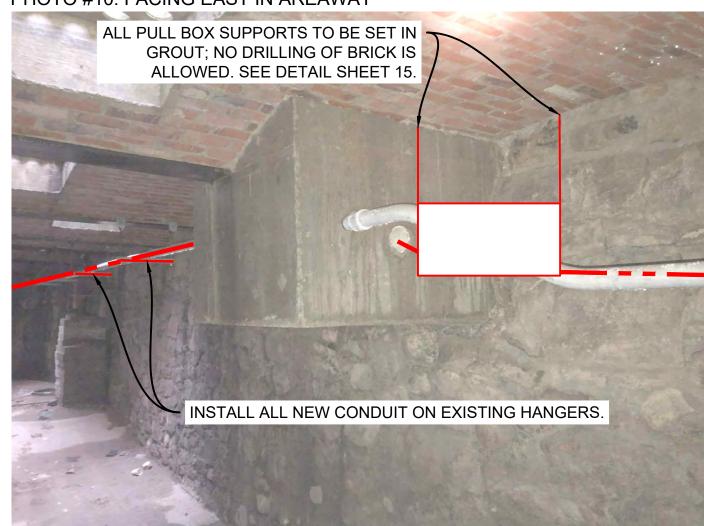


PHOTO #11: FACING EAST IN AREAWAY


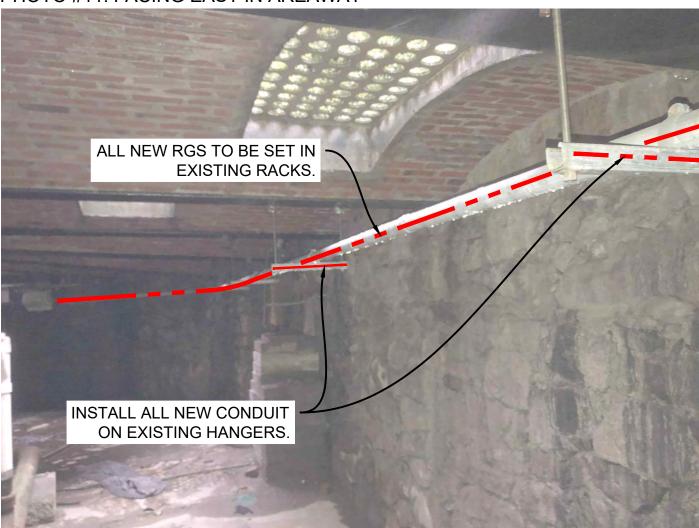


PHOTO #12: FACING EAST IN AREAWAY

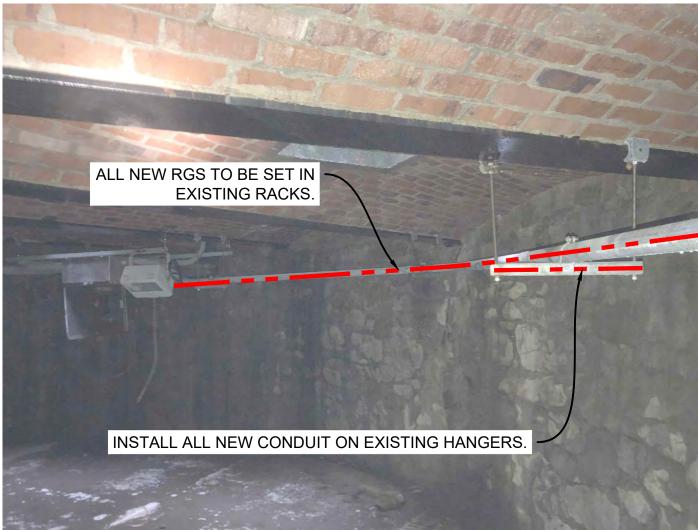


REMOVE EXISTING CHIEF SEATTLE BASE FOUNDATION AND INSTALL, SAME LOCATION (1) SCI AND SDOT APPROVED NEW CHIEF SEATTLE BASE FOUNDATION PER SCL CONSTRUCTION STANDARD 1716.38.

CONSTRUCTION NOTES

- (11) CONTRACTOR TO INSTALL (1) NEW NEMA 4X STAINLESS STEEL J-BOX SIMILAR IN SIZE TO TYPE-2 HH. INTERCEPT EXISTING CONDUIT. MOUNTING OF J-BOX TO BE APPROVED BY STRUCTURAL ENGINEER AND SDOT IN AREA WAY.
- (12) CONTRACTOR TO INSTALL (2) 2" RGS CONDUIT FROM J-BOX-3 TO J-BOX-4. INSTALL PER SCL CONSTRUCTION STANDARD 0095.60 AND 1716.07.
- CONTRACTOR TO INSTALL (1) 1.25" AND (1) 2" RGS CONDUIT FROM J-BOX-4 TO ASSET# 1313162. INSTALL PER SCL CONSTRUCTION STANDARD 0095.60 AND 1716.07.
- EXISTING ZAYO VAULT PLACED UNDER PERMIT #366932. CORE VAULT AND PLACE CONDUIT FROM TRENCH.
- (15) PROPOSED OPEN TRENCH 1-2" CONDUIT FROM EXISTING ZAYO VAULT TO THE NEWLY-INSTALLED POLE BASE FOUNDATION. COORDINATE WITH SCL STREET LIGHT CREW DURING THE INSTALLATION OF CONDUIT FROM VAULT.

PHOTO #13: FACING SOUTH IN AREAWAY

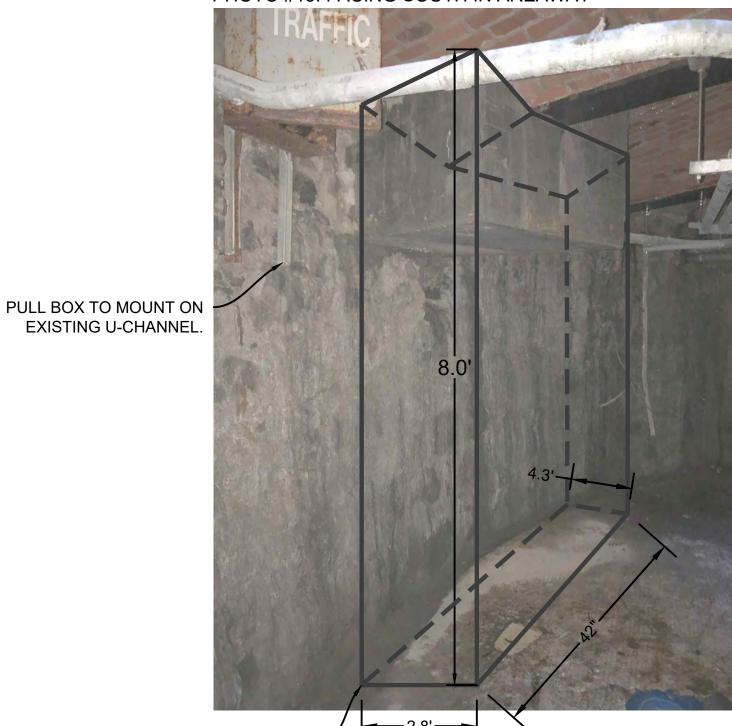


EXISTING FOUNDATION TO BE REMOVED.

REMOVED AFTER CONSTRUCTION. NEW


CONCRETE FORMS TO BE BUILT AND

FOUNDATION TO BE SET IN NEW CONCRETE PILLAR TO THE FLOOR.

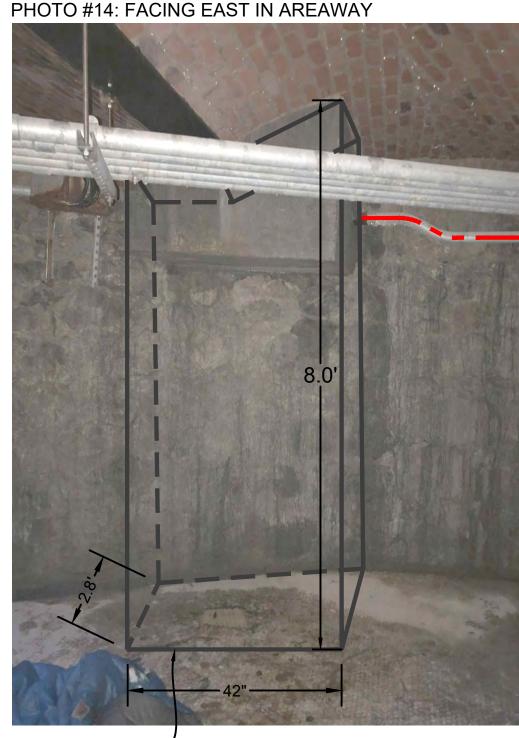

EXISTING FOUNDATION TO BE REMOVED. CONCRETE FORMS TO BE BUILT AND REMOVED AFTER CONSTRUCTION. NEW FOUNDATION TO BE SET IN NEW CONCRETE PILLAR TO THE FLOOR.

PHOTO #15: FACING WEST ON EAST SIDE OF 2ND AVE

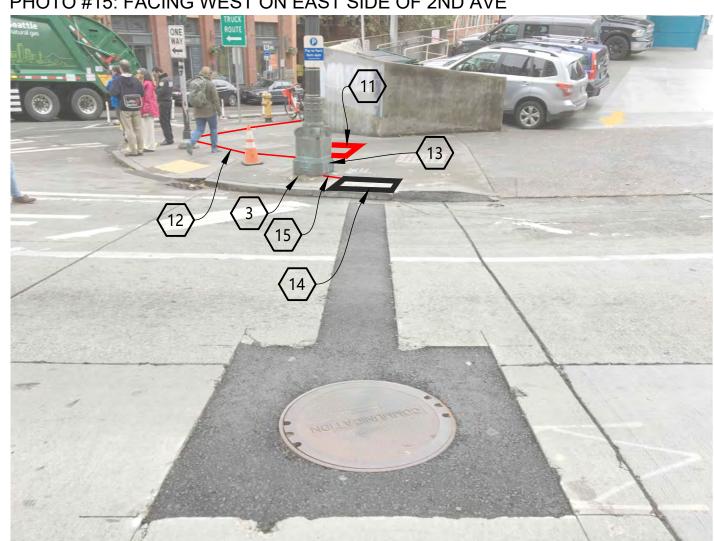

EXISTING CONDUIT AND PULL BOXES TO BE BROUGHT UP TO SDOT AND SCL STANDARDS TO MAITAIN AREAWAY.

PROJECT ENGINEER STAMP

3				AS-BUILT
2	2/17/21	KW	KAW	REVISION # 4
1	3/23/20	MF	DDS	ORIGINAL
NO.	DATE	ENGINEER	DRAFTER	COMMENT





CLIENT PROJECT MANAGER: GIN VILANTE **ENGINEERING FIRM: MGC TECHNICAL CONSULTING INC.**

PROJECT NUMBER: 15586-023-E PERMIT #:421117 LOCATION: 515 2ND AVE

SEATTLE, WA 98104 DRAWING NAME: MASTEC - 15586-023-E - PLANS.dwg

CONFIDENTIAL/PROPRIETARY

SHEET: 17 OF 27

Know what's below.

Call before you dig.

SIMULATION PHOTOGRAPH

PHOTO #16: FACING NW ON WEST SIDE OF 2ND AVE

NEW PANEL ANTENNAS


NEW EQUPIMENT ENCLOSURE

PHOTO #15: FACING SE ON WEST SIDE OF 2ND AVE

NEW MAST ARM AND LIGHT FIXTURE



- (3) REMOVE EXISTING CHIEF SEATTLE BASE FOUNDATION AND NEW CHIEF SEATTLE BASE FOUNDATION PER SCL CONSTRUCTION STANDARD 1716.38.
- EXISTING ZAYO VAULT PLACED UNDER PERMIT #366932. CORE VAULT AND PLACE CONDUIT FROM TRENCH.

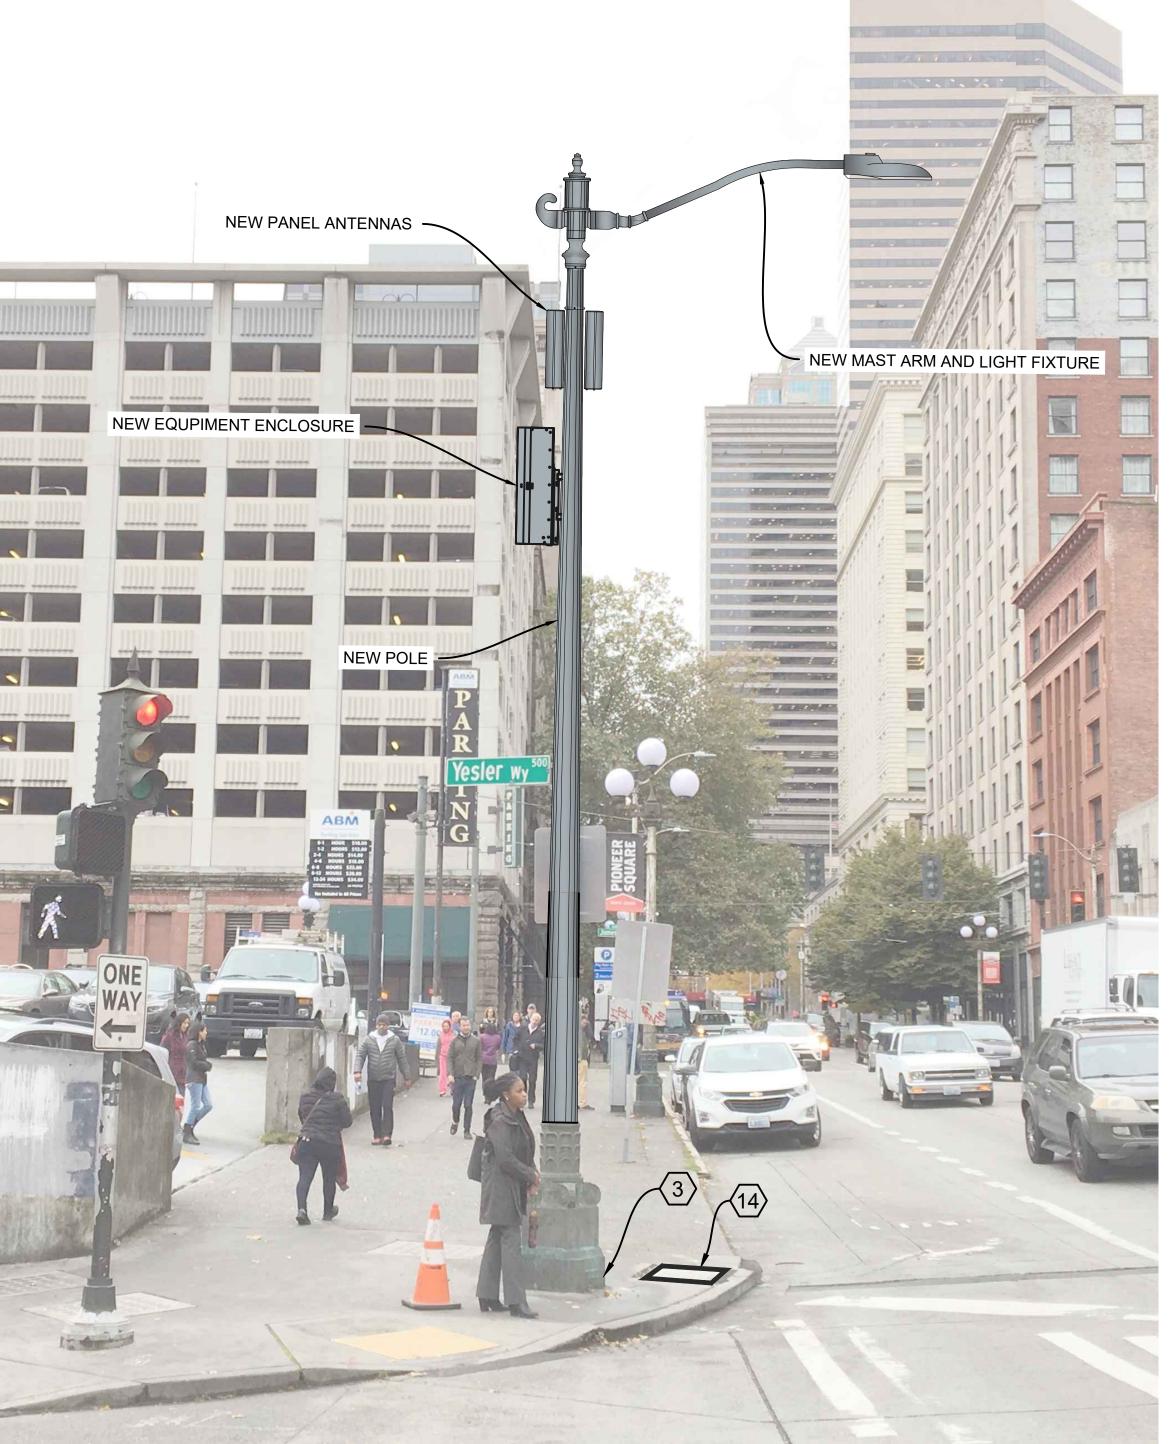

- CONTRACTOR TO COORDINATE WITH SDOT YARD FOR STORAGE OF EXISTING BRONZE BASE. TO BE RE-INSTALLED ON 2. NEW EQUIPMENT TO BE PAINTED WITH
- SHERWIN-WILLIAMS POWDURA TGIC POWDER COATING, DGS2-40003, RAILROAD GREEN. RF TRANSPARENT AND UV RESISTANT OUTDOOR RATED PAINT.

PROJECT ENGINEER STAMP

NO.	DATE	ENGINEER	DRAFTER	COMMENT
1	3/23/20	MF	DDS	ORIGINAL
2	2/17/21	KW	KAW	REVISION # 4
3				AS-BUILT





SHEET: 18 OF 27

CLIENT PROJECT MANAGER: GIN VILANTE **ENGINEERING FIRM: MGC TECHNICAL CONSULTING INC.**


PROJECT NUMBER: 15586-023-E PERMIT #:421117 LOCATION: 515 2ND AVE

SEATTLE, WA 98104

DRAWING NAME: MASTEC - 15586-023-E - PLANS.dwg

CONFIDENTIAL/PROPRIETARY

RF WARNING SIGN DETAILS

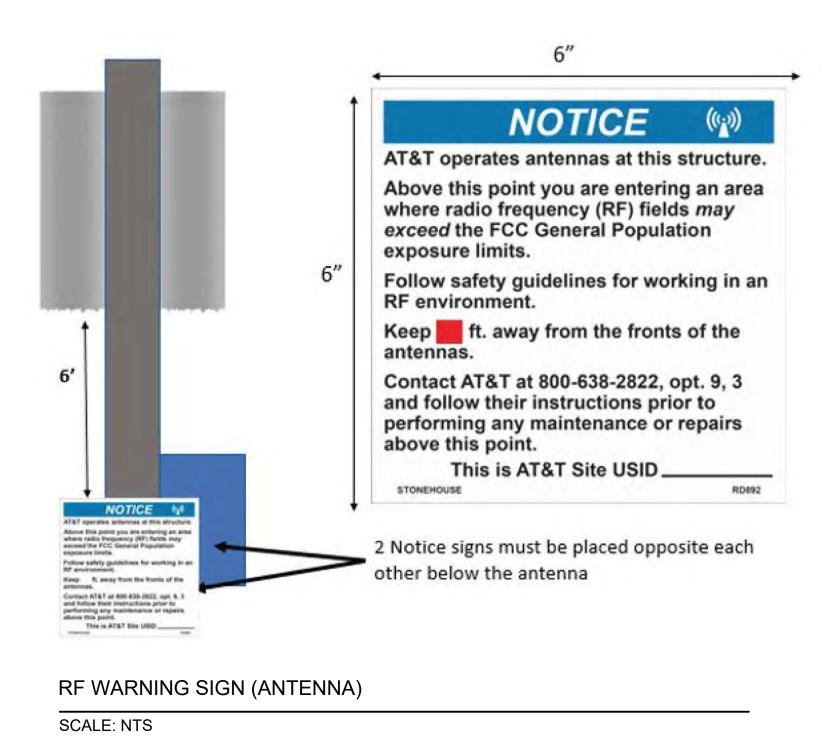

Signage must be ordered from Stonehouse Signs Inc., according to the guidance in Section 6.2 "Stonehouse signs ordering process (CRAN) in ATT-790-202-062 DAS (Distributed Antenna System) and CRAN (Centralized Radio Access Network) Signage Standard." http://apex.web.att.com/bookview/bookview.jsp?bookname=ATT-790-202-062&fulltext

- 1. Stonehouse ordering part number for this sign is: "RD899"
- 2. Sign Dimensions are: height= 2.5", width=6.5"
- 3. Use the supplied number pad to enter the number 1 into the blank space as shown in the sign diagram

RF WARNING SIGN (PLACEMENT) SCALE: NTS



NO.	DATE	ENGINEER	DRAFTER	COMMENT
1	3/23/20	MF	DDS	ORIGINAL
2	2/17/21	KW	KAW	REVISION # 4
3				AS-BUILT






PROJECT NUMBER: 15586-023-E PERMIT #:421117

LOCATION: 515 2ND AVE

SEATTLE, WA 98104 DRAWING NAME: MASTEC - 15586-023-E - PLANS.dwg

SHEET: 19 OF 27



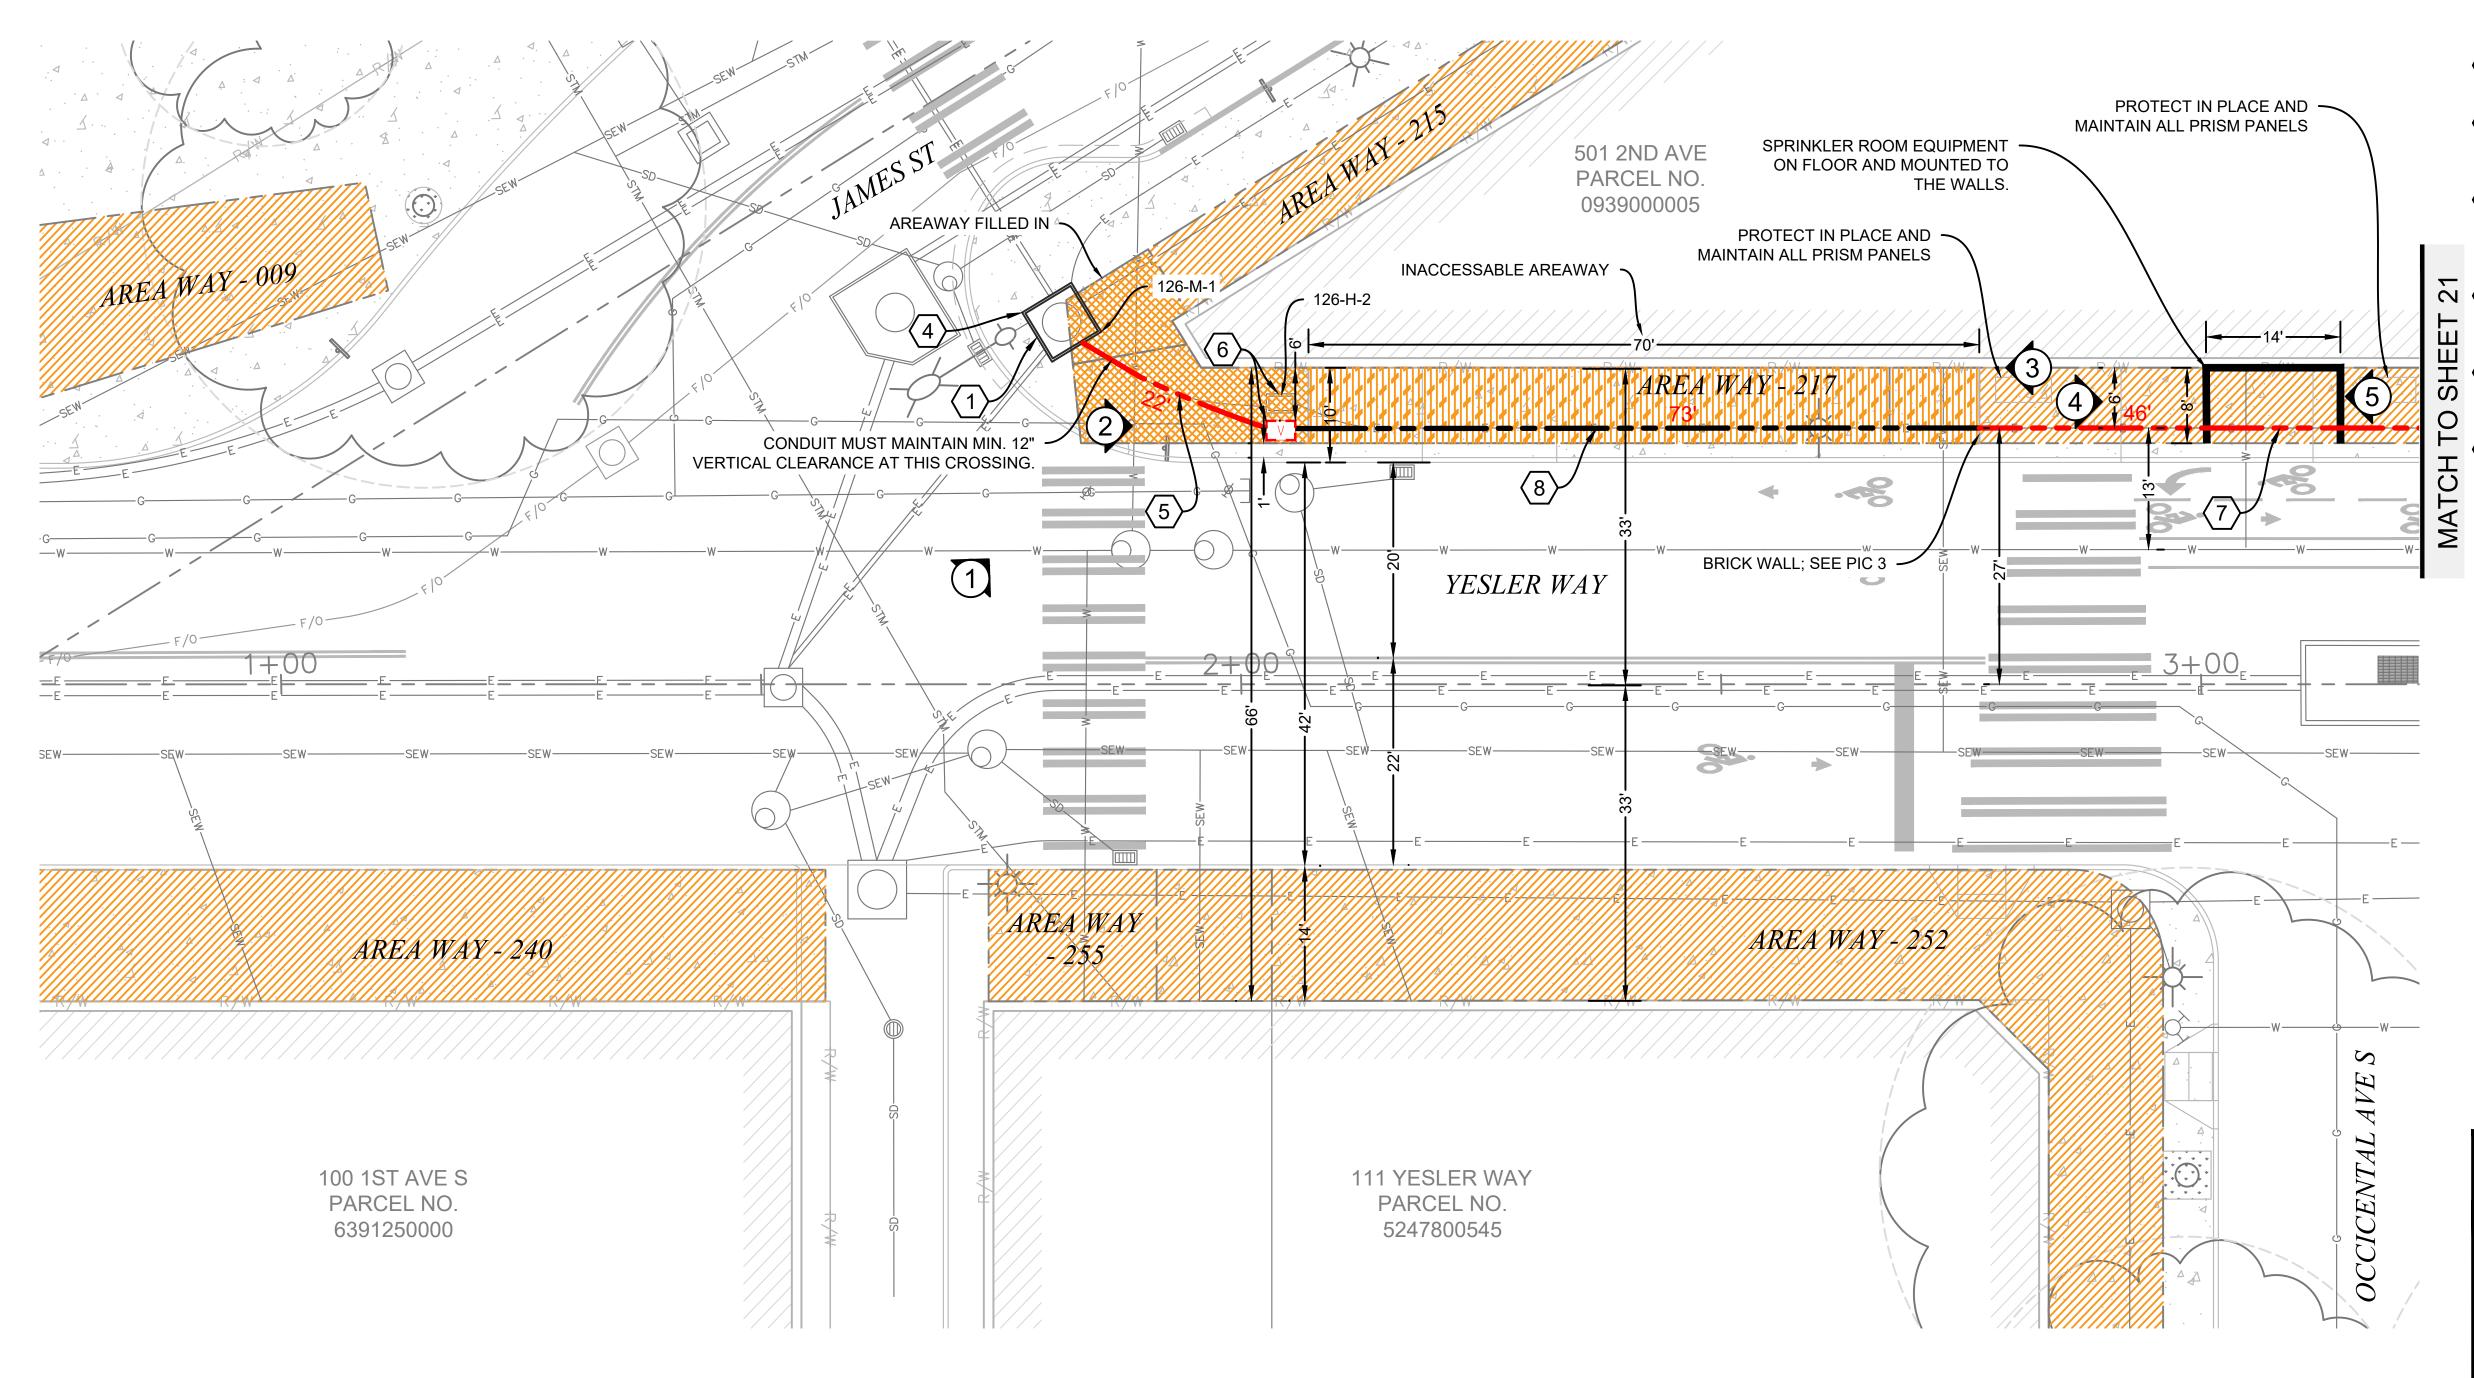

CONTRACTOR NOTES

- PROTECT CURB AND SIDEWALK, RESTORE IF DAMAGED PER
- CURRENT COS STANDARD PLANS.
- 2. PRESERVE AND PROTECT EXISTING TRAFFIC SIGNAL EQUIPMENT, OR REPLACE IF DAMAGED.
- PROTECT ALL EXISTING SIGNAGE; RESTORE IF DAMAGED PER **CURRENT COS STANDARD.**
- 4. PROTECT SURVEY MONUMENTS; ADJUST AND RESTORE IF DAMAGED PER CURRENT COS STANDARD PLANS.
- ALL EXCAVATION WITHIN DRIP LINE OF TREE SHALL BE COMPLETED VIA VAC TRUCK. PROTECT ROOTS GREATER THAN 2" WITH BURLAP. REMOVE BURLAP AFTER CONSTRUCTION. (WHEN WORKING WITHIN DRIP LINE OF TREES).
- 6. LOCATE AND PROTECT ALL STREET LIGHT INFRASTRUCTURE PRIOR TO CONSTRUCTION.
- LOCATE AND PROTECT ALL PRIVATE SIDE SEWER. 8. EXISTING BRONZE BASE. CONTRACTOR TO COORDINATE WITH SDOT YARD STORAGE FOR FUTURE USE.

PSE NOTES

- 2. MAINTAIN A MINIMUM 3' HORIZONTAL SEPARATION WHEN RUNNING PARALLEL TO GAS MAINS OR SERVICES.
- 3. IF HP IS ENCOUNTERED, PLEASE CONTACT PSE PI INSPECTOR BEFORE WORKING NEAR HP GAS MAINS: GLENN HUDEN -PHONE: 206-396-4159 - EMAIL: GLENN.HUDEN@PSE.COM
- 4. COORDINATE WITH PSE CUSTOMER CONSTRUCTION SERVICES AT 1-888-321-7779 AND A PSE PROJECT MANAGER FOR



- 1 COORDINATE WITH STREETLIGHT CREW FOR SERVICE DISCONNECTION FROM MH 126-M-1 TO ASSET#1313162.
- 4 EXISTING SCL VAULT 126-M-1, CONTRACTOR TO CORE VAULT AND INSTALL CONDUIT PER SCL CONSTRUCTION STANDARD 7020.05.
- (5) CONTRACTOR TO TRENCH AND REMOVE EXISTING CONDUIT. INSTALL (2) 3" RGS CONDUIT FROM MH 126-M-1 TO 126-H-2. INSTALL PER SCL CONSTRUCTION STANDARD 0095.60 AND 1716.07.
- 6 CONTRACTOR TO REPLACE HH 126-H-2 WITH (1) NEW TYPE-5 SL HH PER COS STD PLAN 550A AND SCL CONSTRUCTION STANDARD 1716.07.
 - 7 CONTRACTOR TO INSTALL (1) 3-1/2" RGS CONDUIT FROM EXISTING 3-1/2" RGS TO J-BOX-2. INSTALL PER SCL CONSTRUCTION STANDARDS 0095.60 AND 1716.07.
- 8 PULL THROUGH EXISTING (1) 3-1/2" RGS CONDUIT. FROM NEWLY INSTALLED TYP5 5 HH TO NEWLY INSTALLED 3-1/2"


REFERENCE SCL CUSTOMER DRAWING FOR WORK ORDER



SYMBOL CORRESPONDS TO PHOTO LOCATIONS AND PHOTO.

PROJECT ENGINEER STAMP



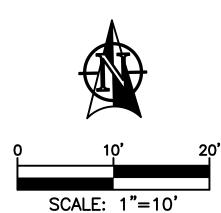







Network Solutions CLIENT PROJECT MANAGER: GIN VILANTE

ENGINEERING FIRM: MGC TECHNICAL CONSULTING INC. PROJECT NUMBER: 15586-023-E PERMIT #:421117


LOCATION: 515 2ND AVE SEATTLE, WA 98104


DRAWING NAME: MASTEC - 15586-023-E - PLANS.dwg


CONFIDENTIAL/PROPRIETARY SHEET: 20 OF 27



RELOCATION OF GAS MAINS AND SERVICES AS NEEDED. LOCATE AND PROTECT ALL GAS FACILITIES IN THE FIELD.

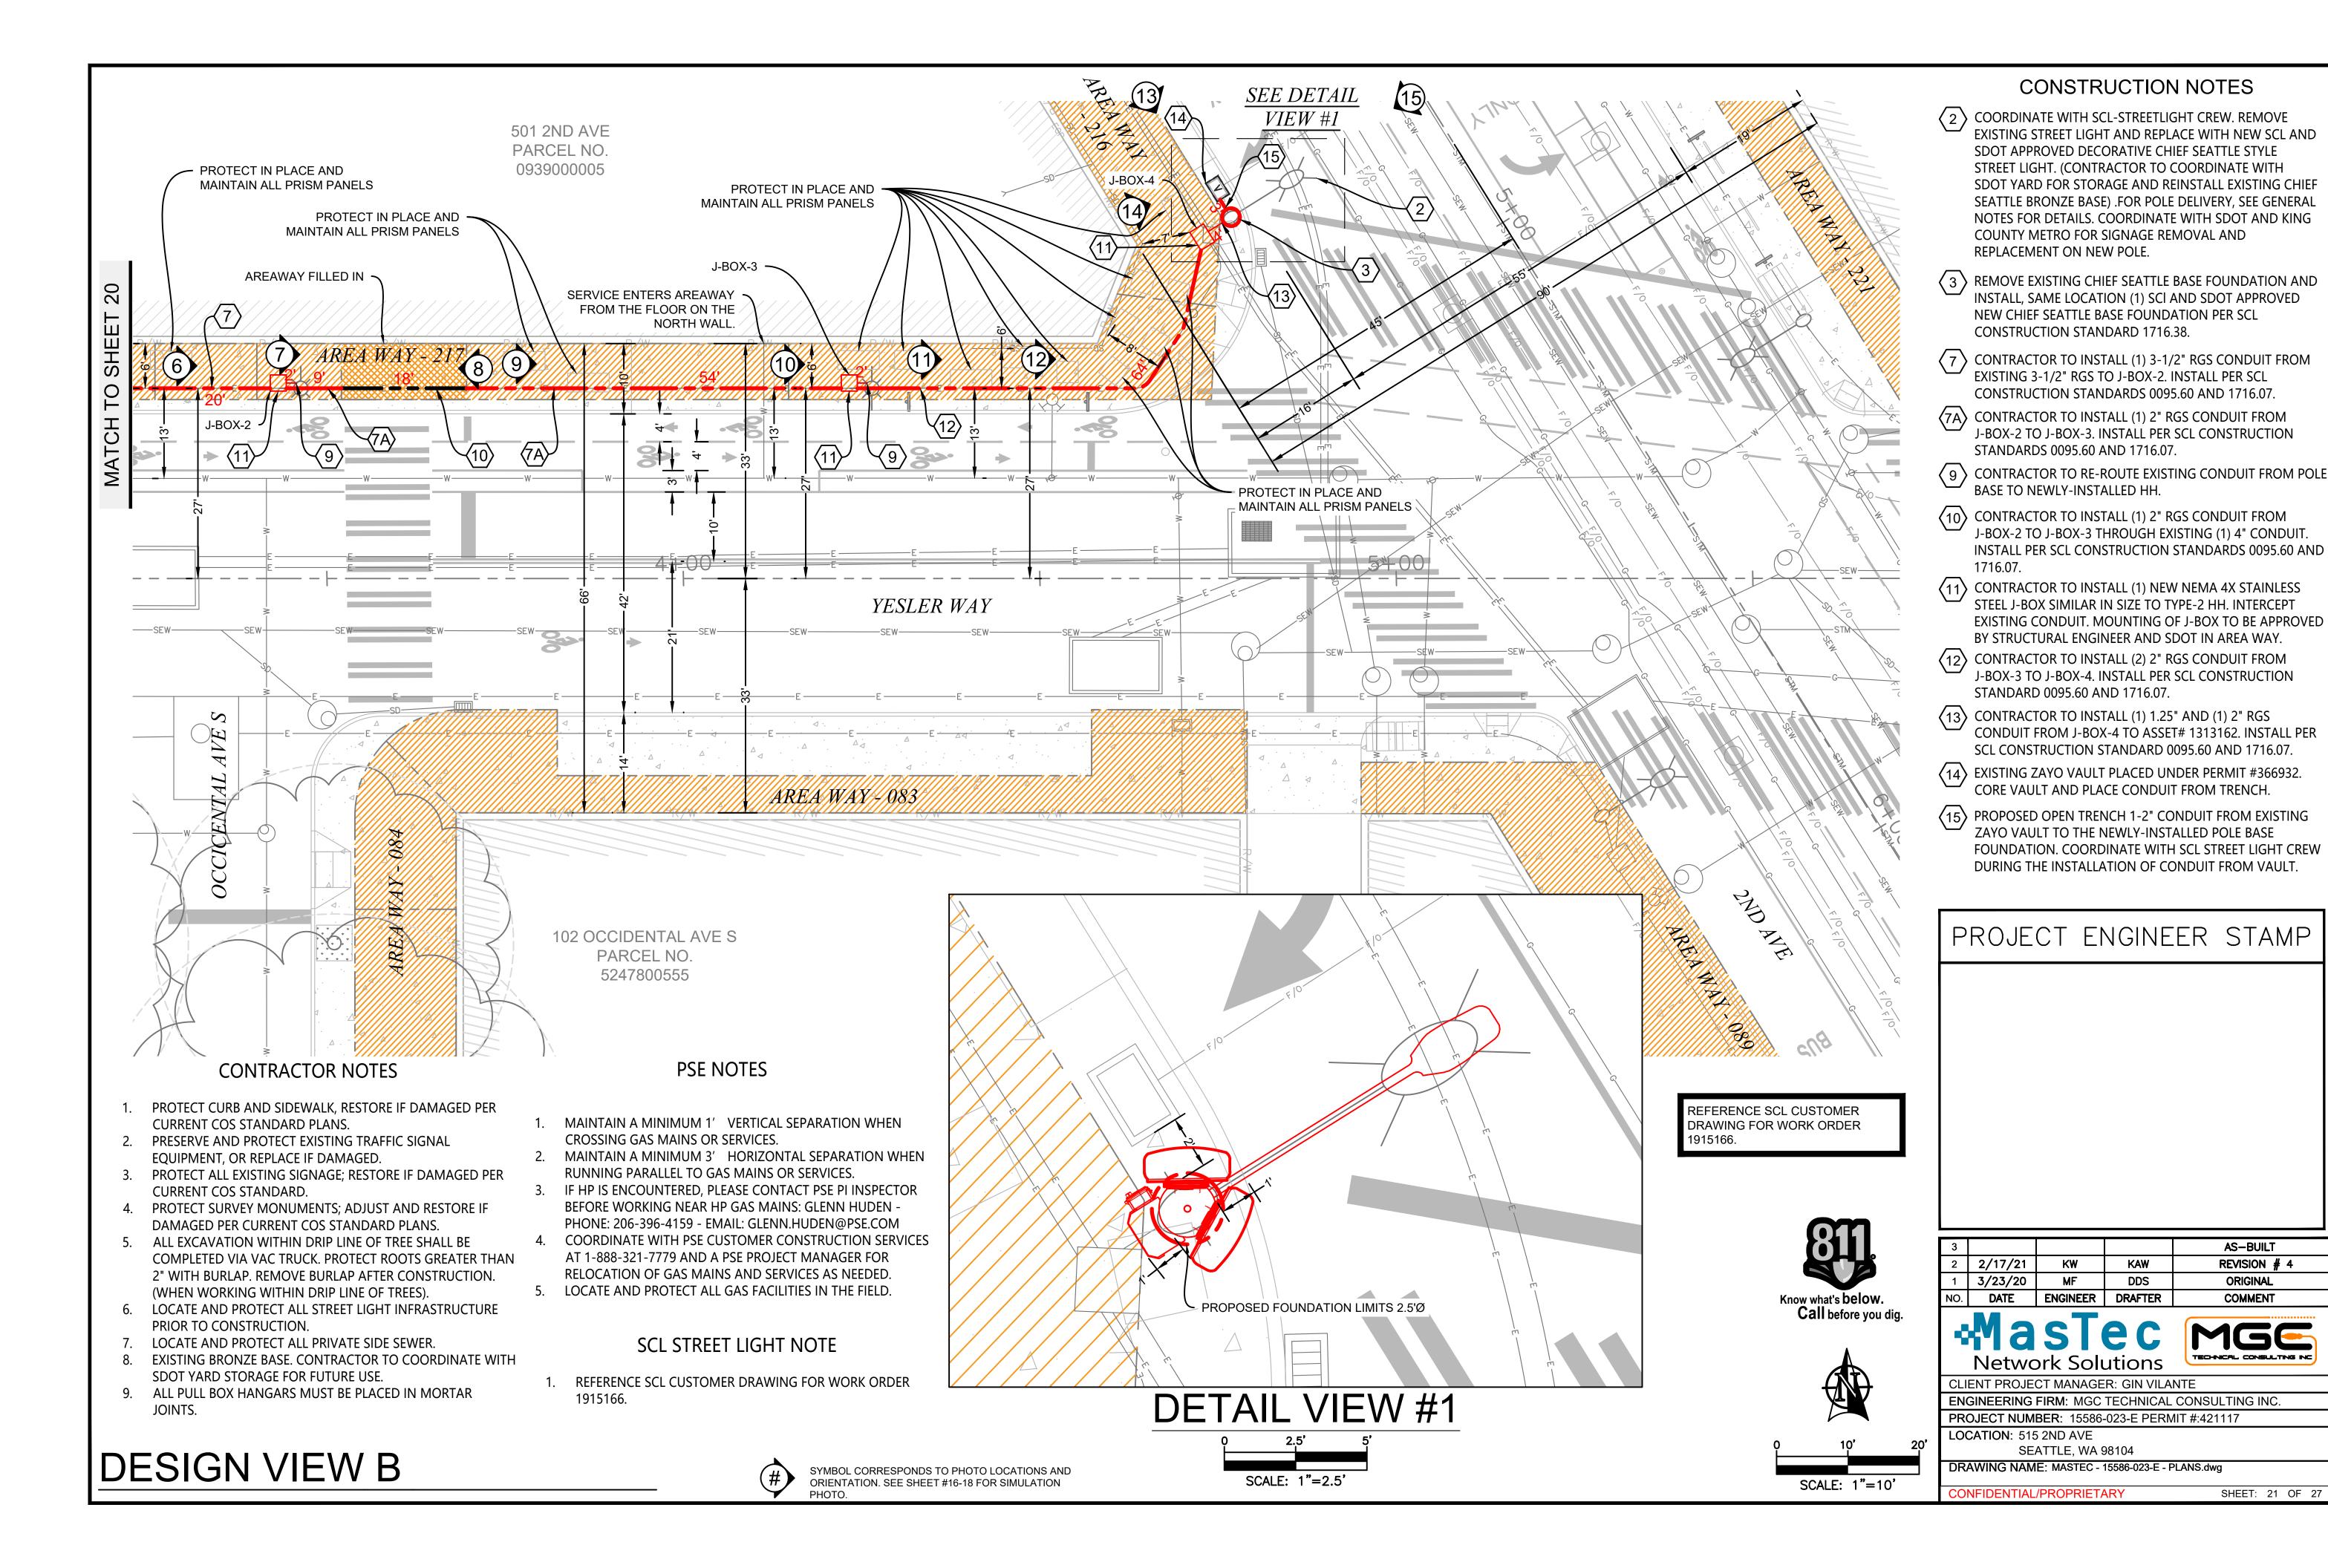

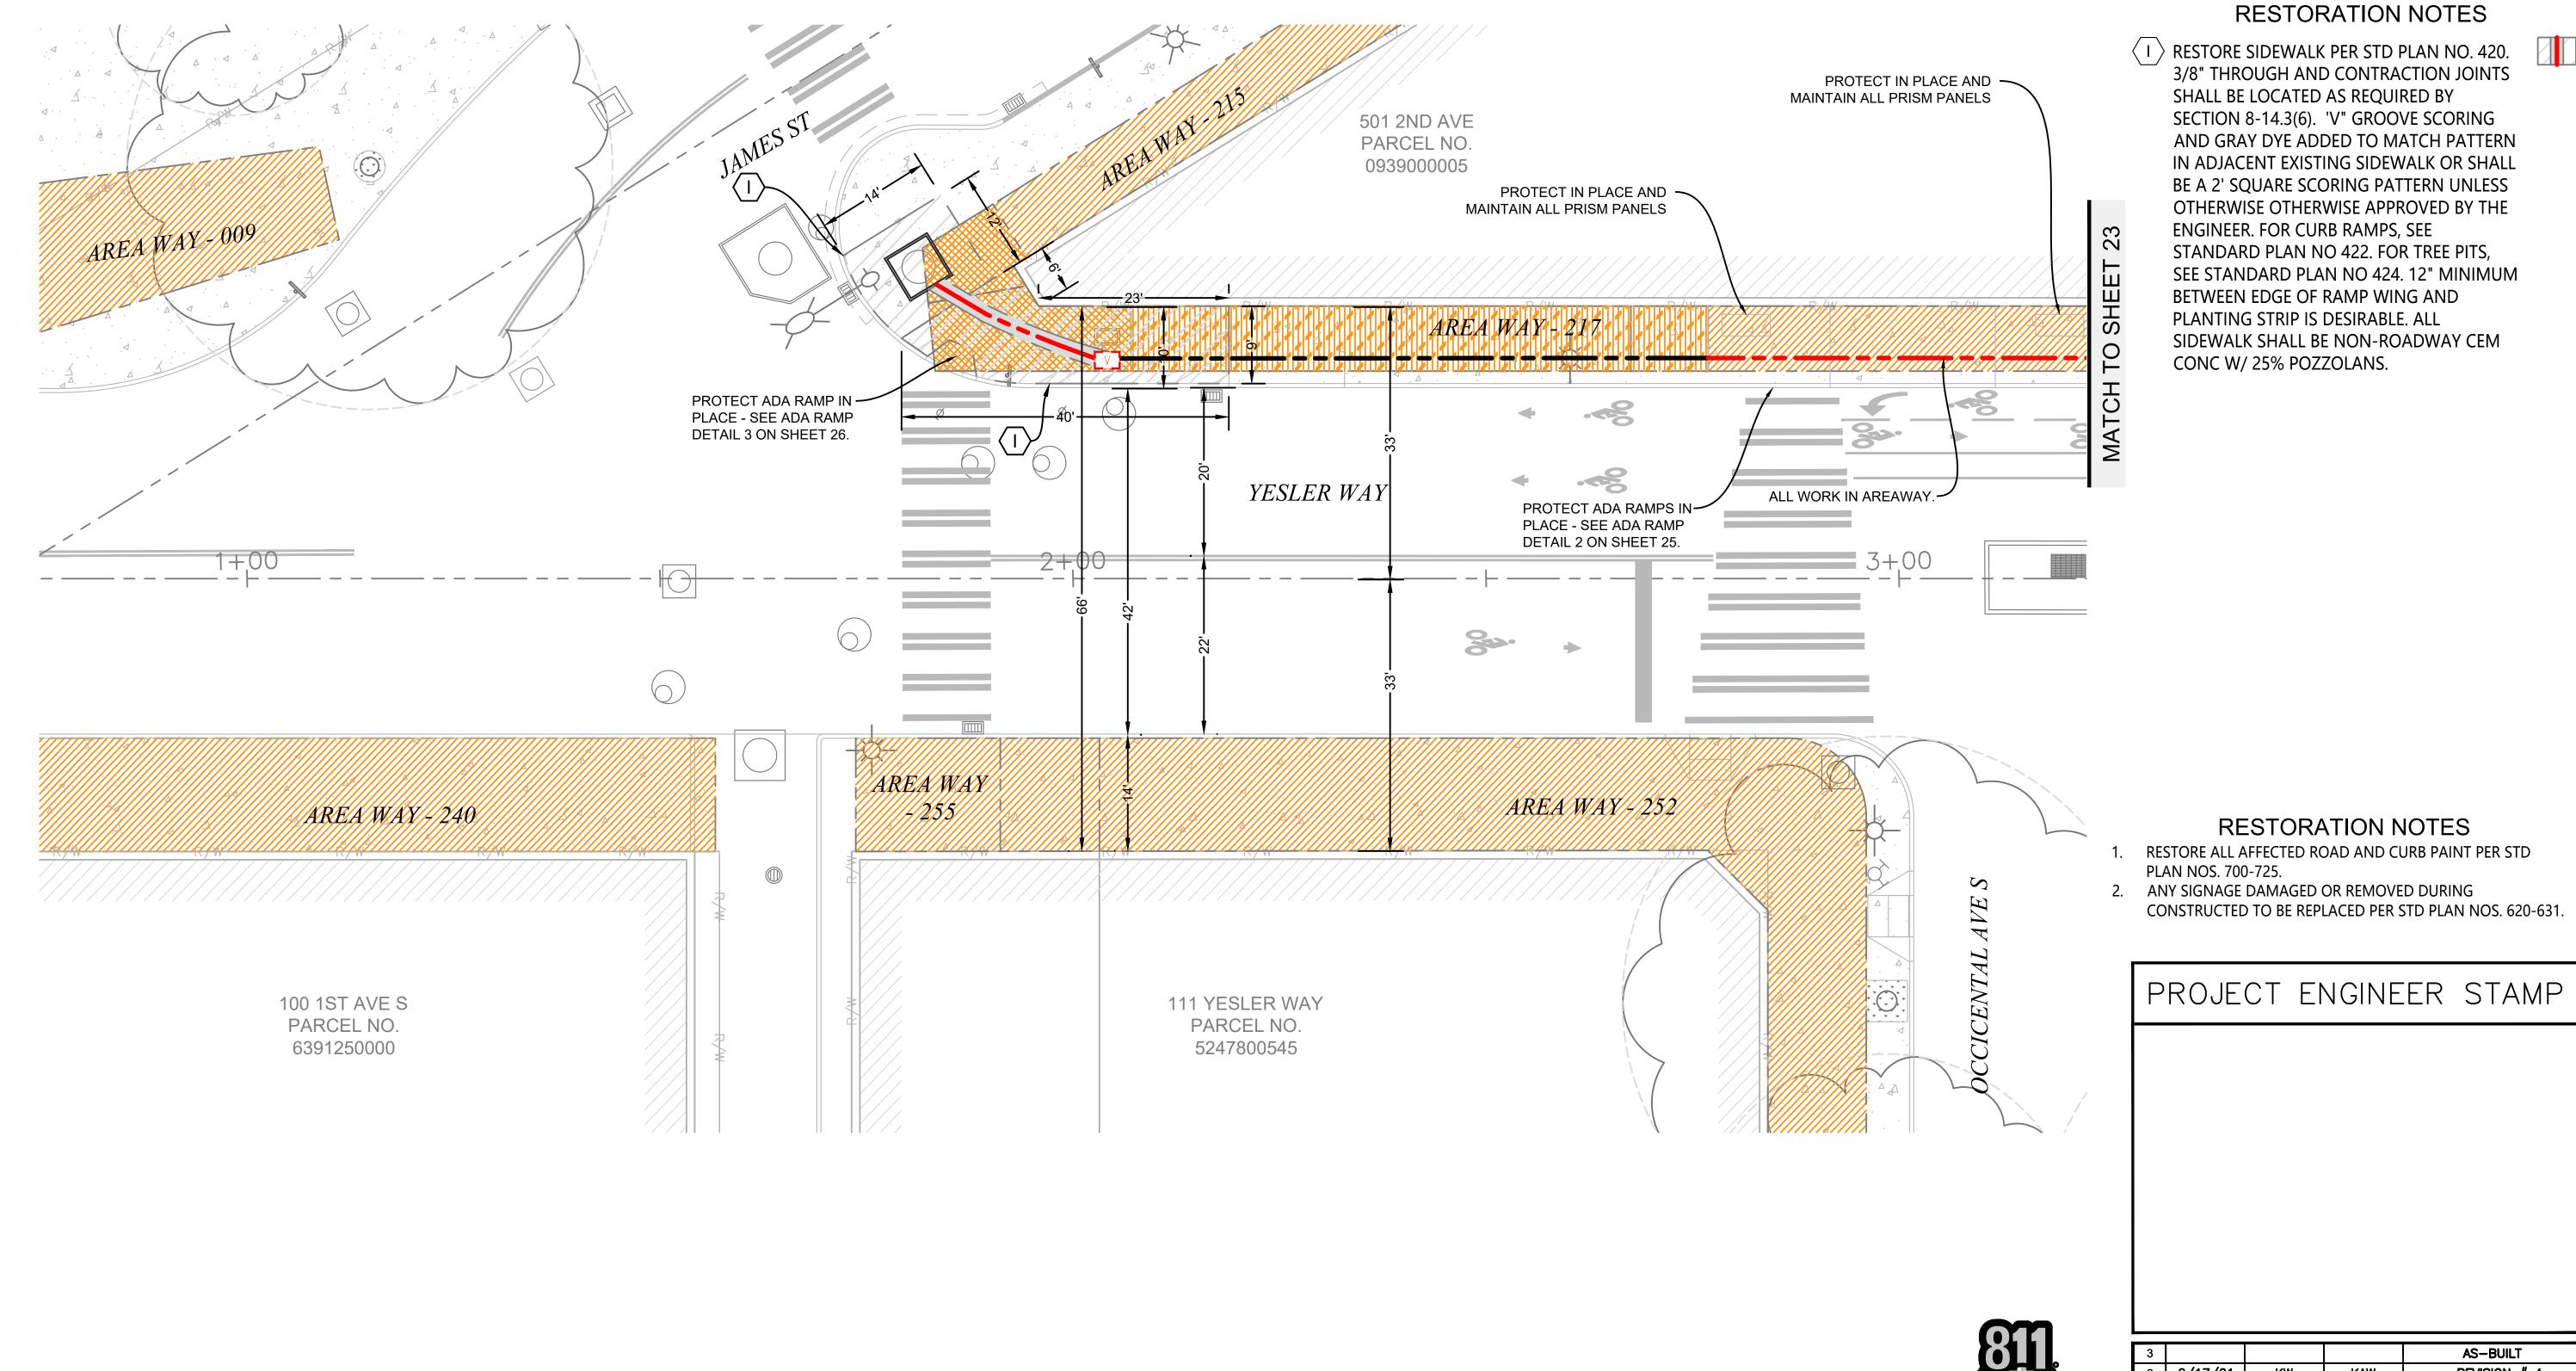

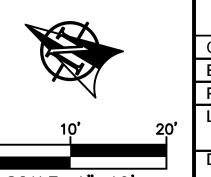

Know what's below.

Call before you dig.







CLIENT PROJECT MANAGER: GIN VILANTE

ENGINEERING FIRM: MGC TECHNICAL CONSULTING INC.

PROJECT NUMBER: 15586-023-E PERMIT #:421117


LOCATION: 515 2ND AVE SEATTLE, WA 98104


DRAWING NAME: MASTEC - 15586-023-E - PLANS.dwg

CONFIDENTIAL/PROPRIETARY SHEET: 22 OF 27

RESTORATION VIEW A

E: 1"=10'

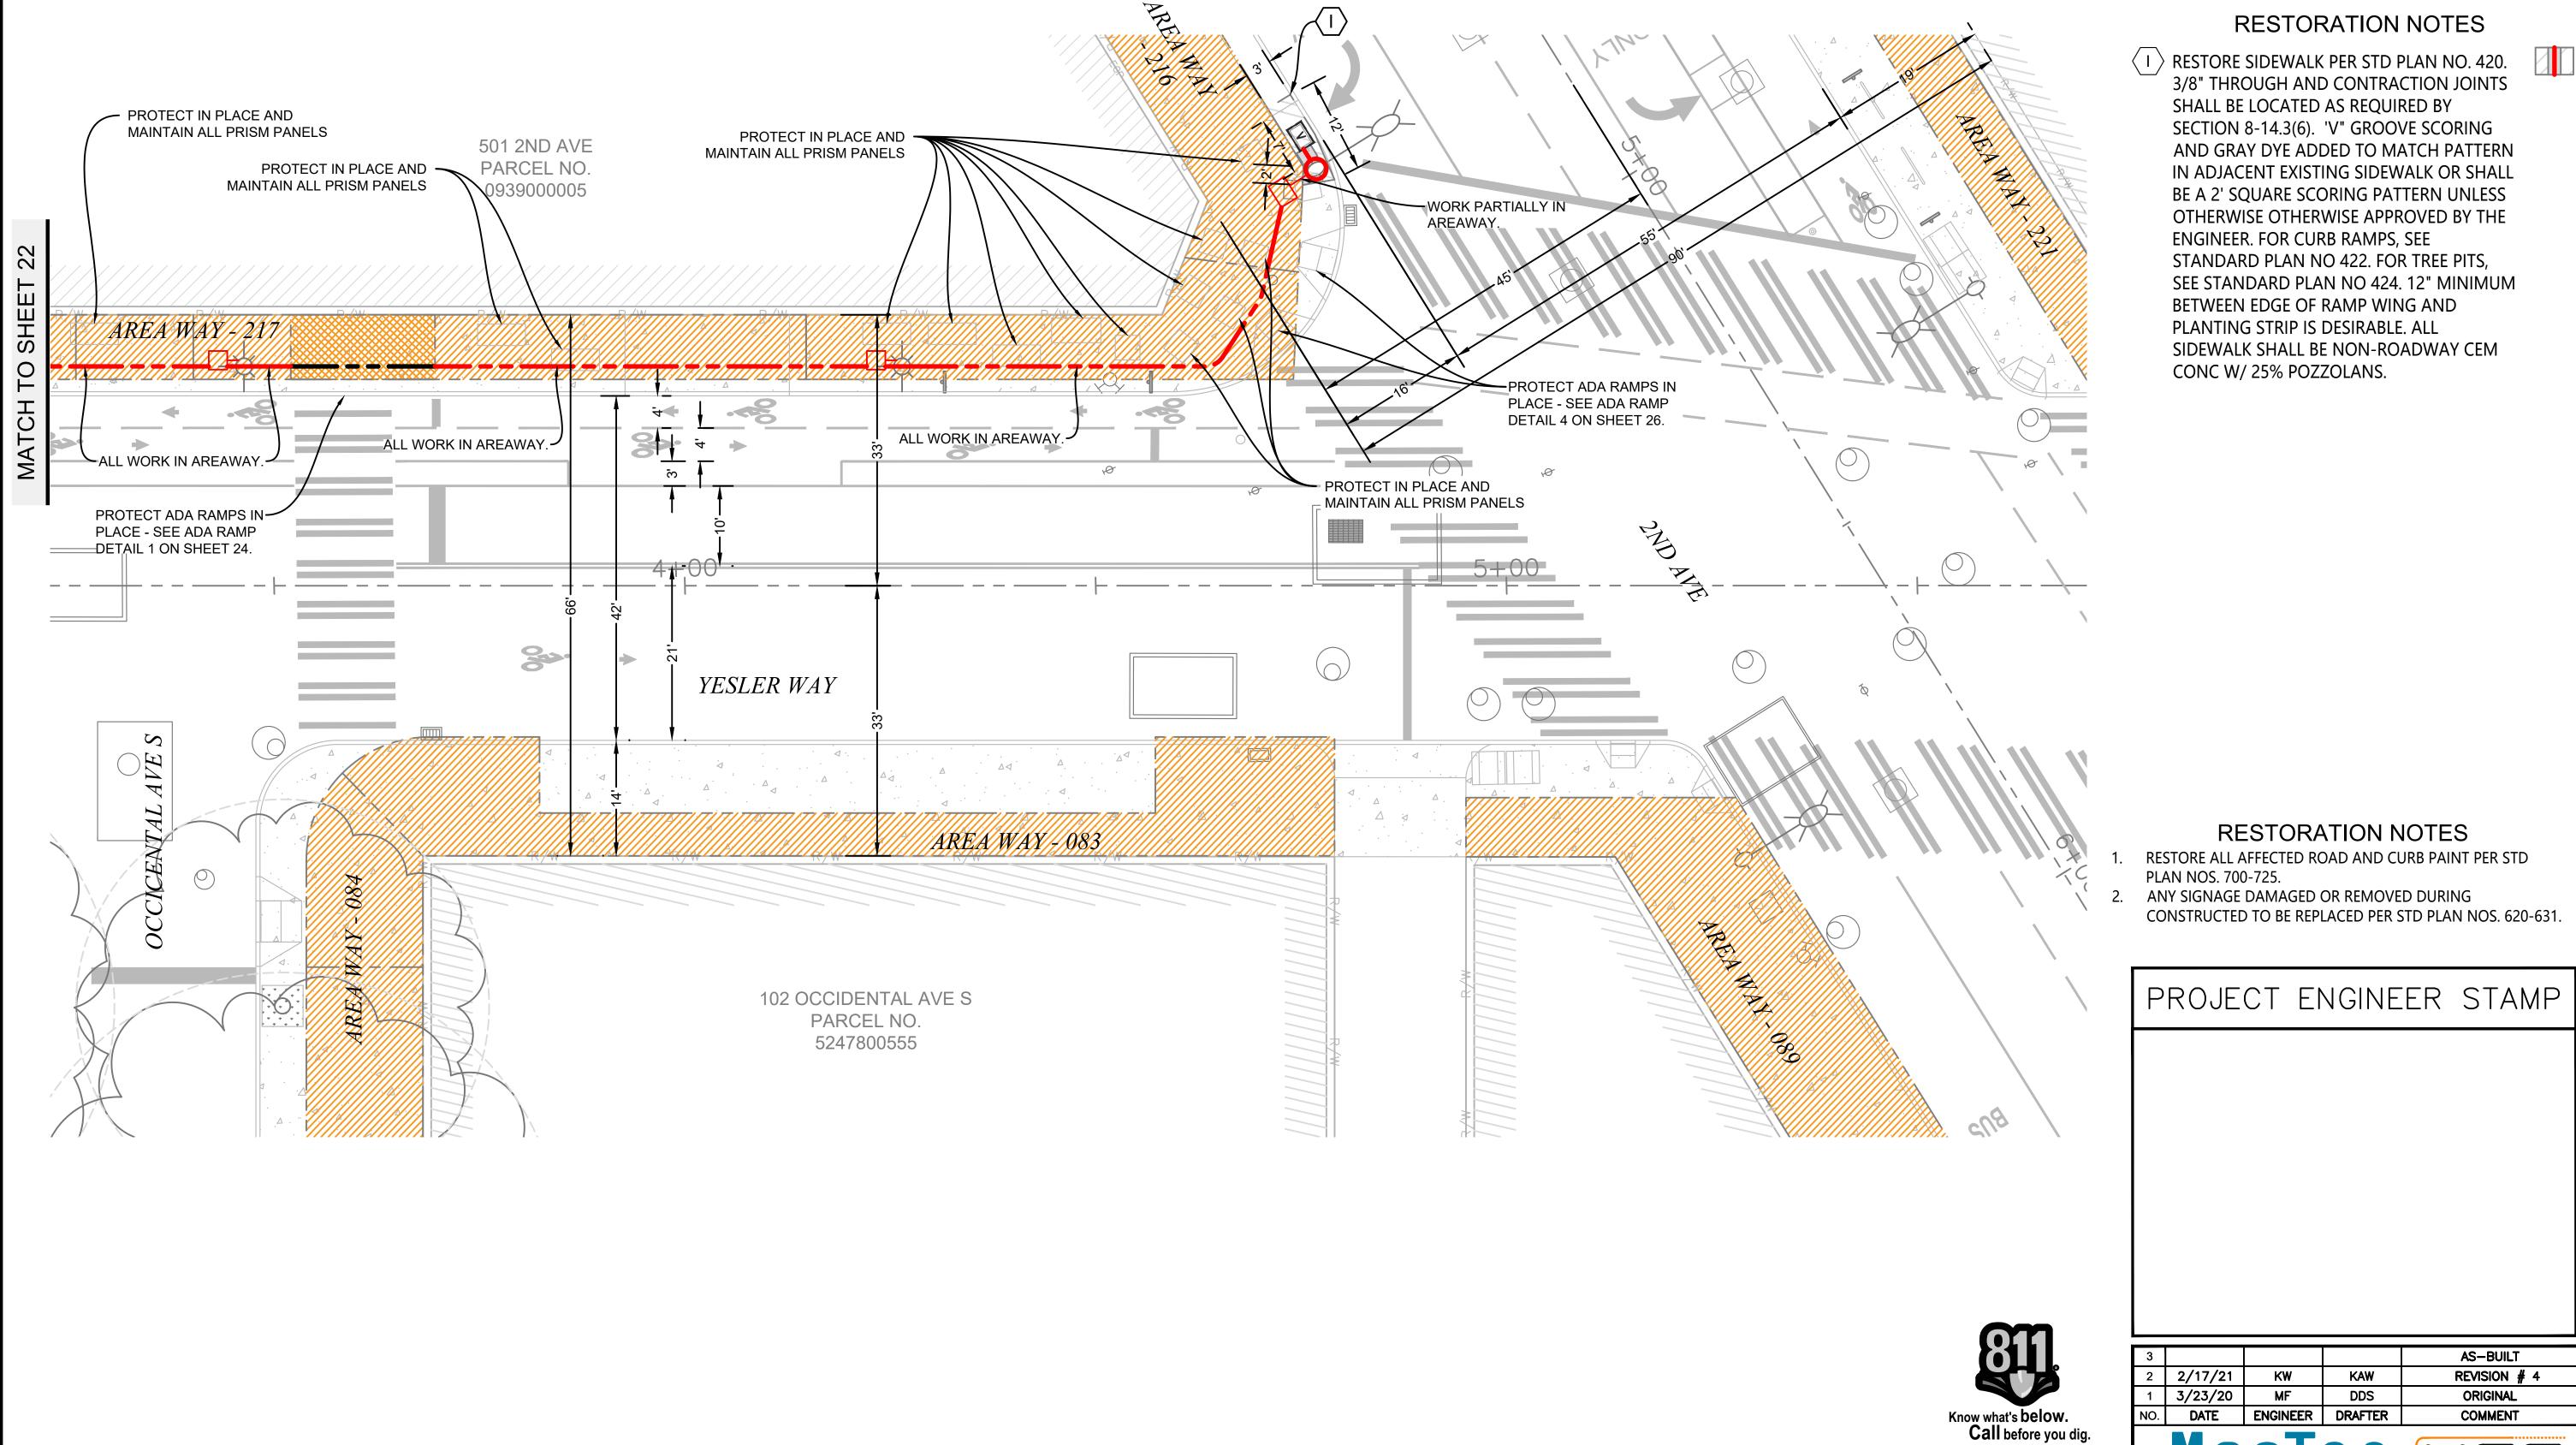

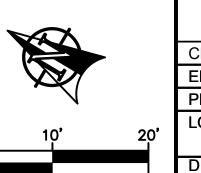

AS-BUILT REVISION # 4 **ORIGINAL** COMMENT





CLIENT PROJECT MANAGER: GIN VILANTE **ENGINEERING FIRM: MGC TECHNICAL CONSULTING INC.** PROJECT NUMBER: 15586-023-E PERMIT #:421117

LOCATION: 515 2ND AVE SEATTLE, WA 98104

DRAWING NAME: MASTEC - 15586-023-E - PLANS.dwg


CONFIDENTIAL/PROPRIETARY

RESTORATION VIEW B

SHEET: 23 OF 27

ADA RAMP DETAIL 1 - NE CORNER YESLER WAY & OCCIDENTAL AVE S

(1) CANNOT INSTALL ADA RAMP AT MARKED CROSSWALK DUE TO EXISTING AREAWAY.

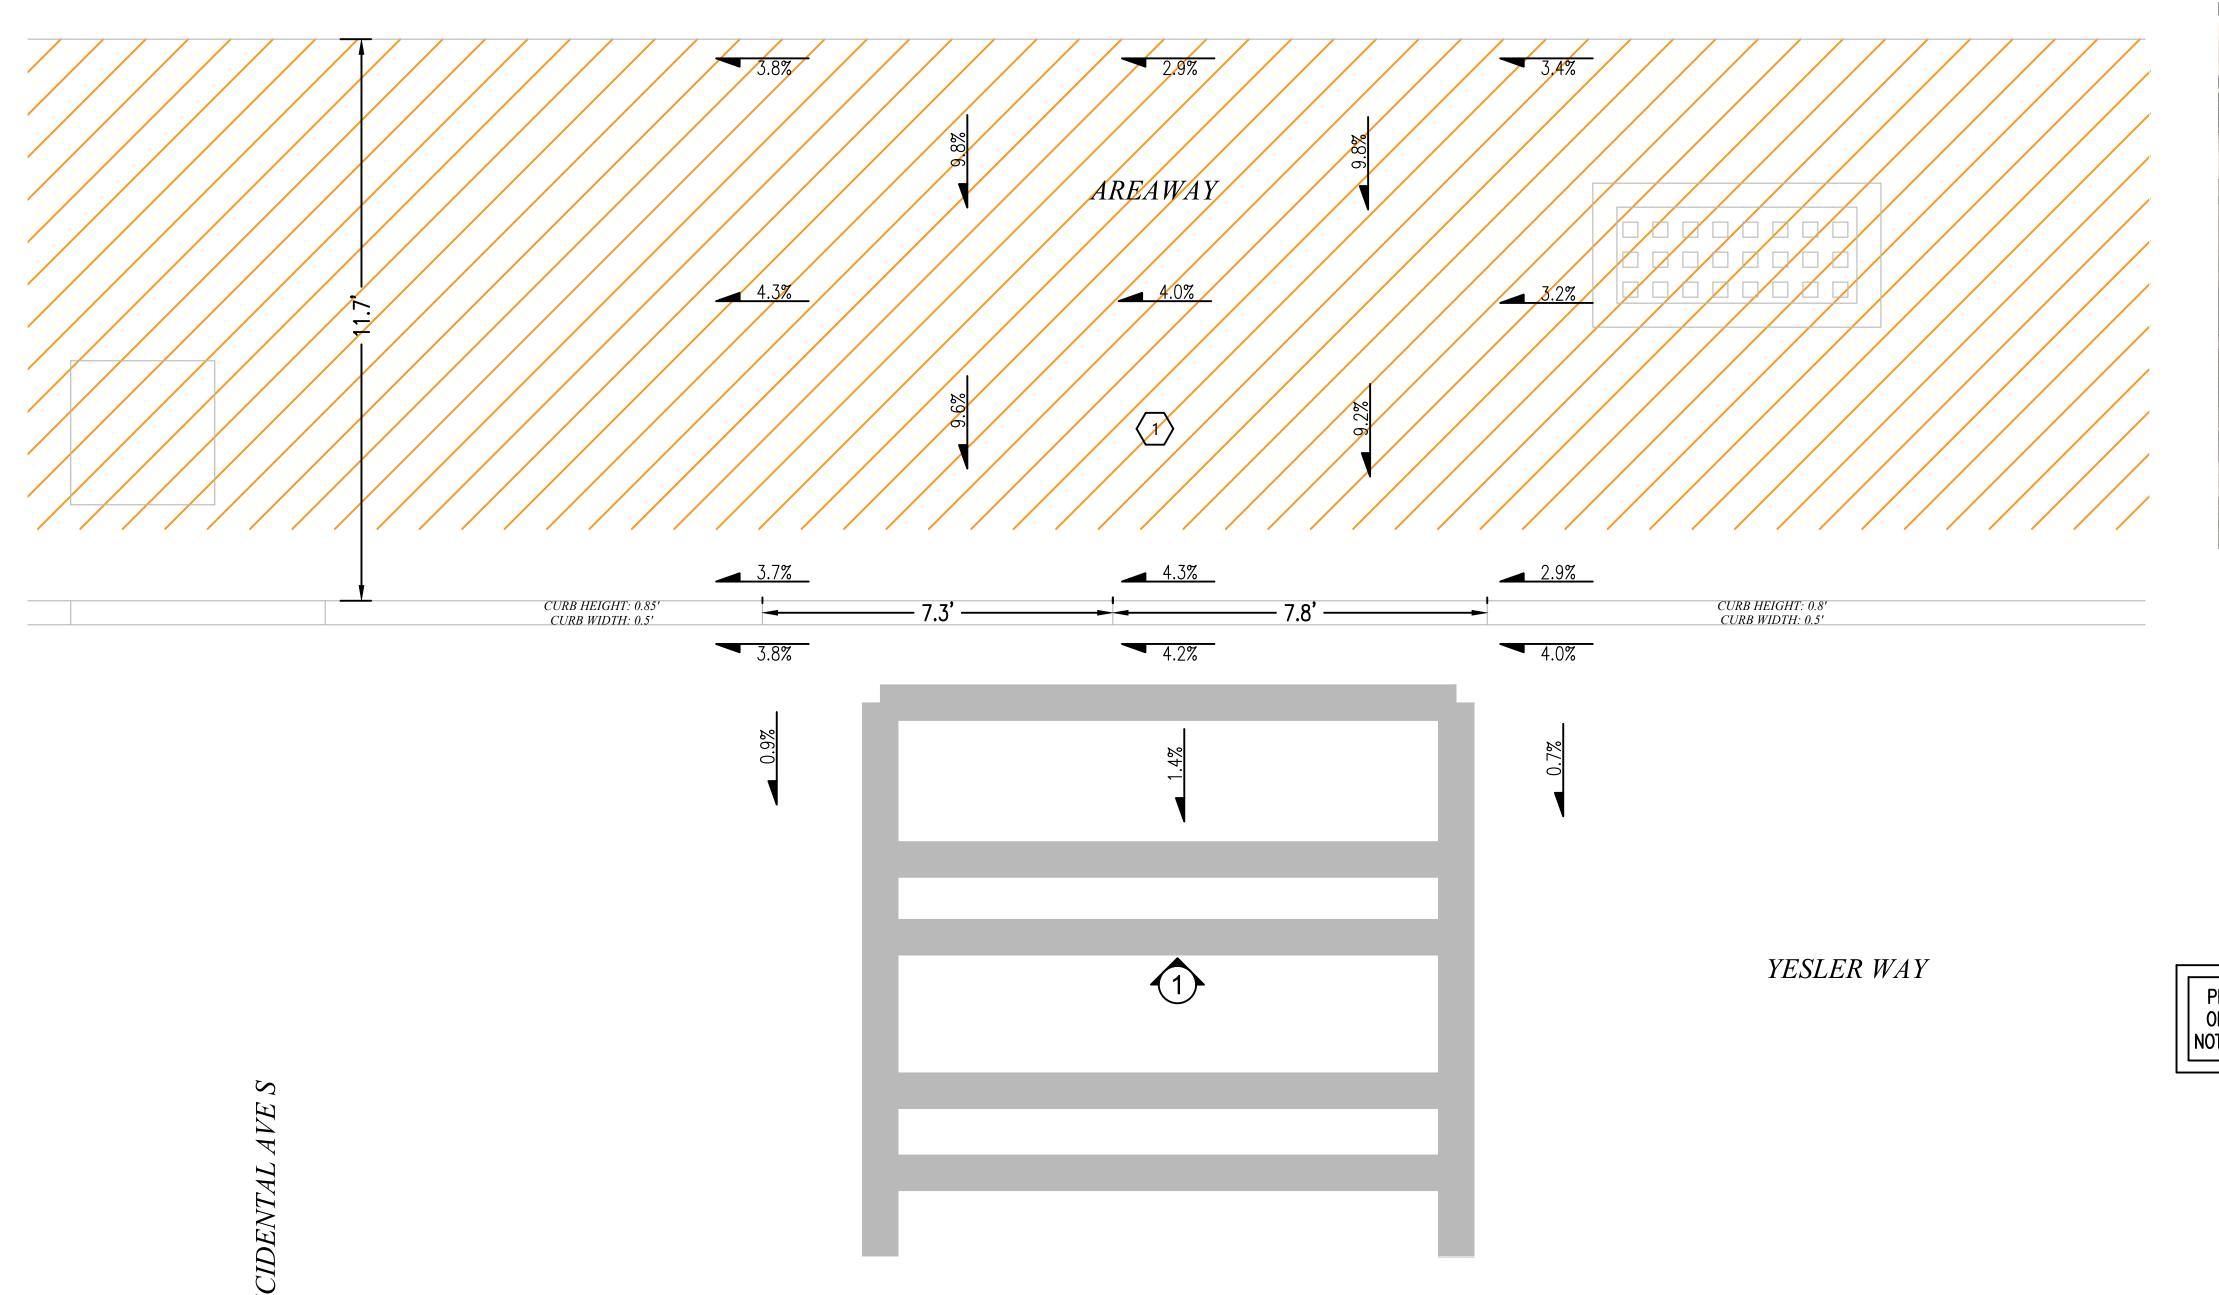








PROJECT ENGINEER STAMP

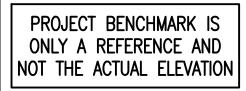



Know what's below.

Call before you dig.

SCALE: NTS



AS-BUILT REVISION # 4 2 2/17/21 ORIGINAL DATE ENGINEER DRAFTER COMMENT





CLIENT PROJECT MANAGER: GIN VILANTE ENGINEERING FIRM: MGC TECHNICAL CONSULTING INC. PROJECT NUMBER: 15586-023-E PERMIT #:421117

LOCATION: 515 2ND AVE SEATTLE, WA 98104


DRAWING NAME: MASTEC - 15586-023-E - PLANS.dwg

SHEET: 24 OF 27

CONFIDENTIAL/PROPRIETARY

ADA RAMP DETAIL 2 - NW CORNER YESLER WAY & OCCIDENTAL AVE S

(1) CANNOT INSTALL ADA RAMP AT MARKED CROSSWALK DUE TO EXISTING AREAWAY.

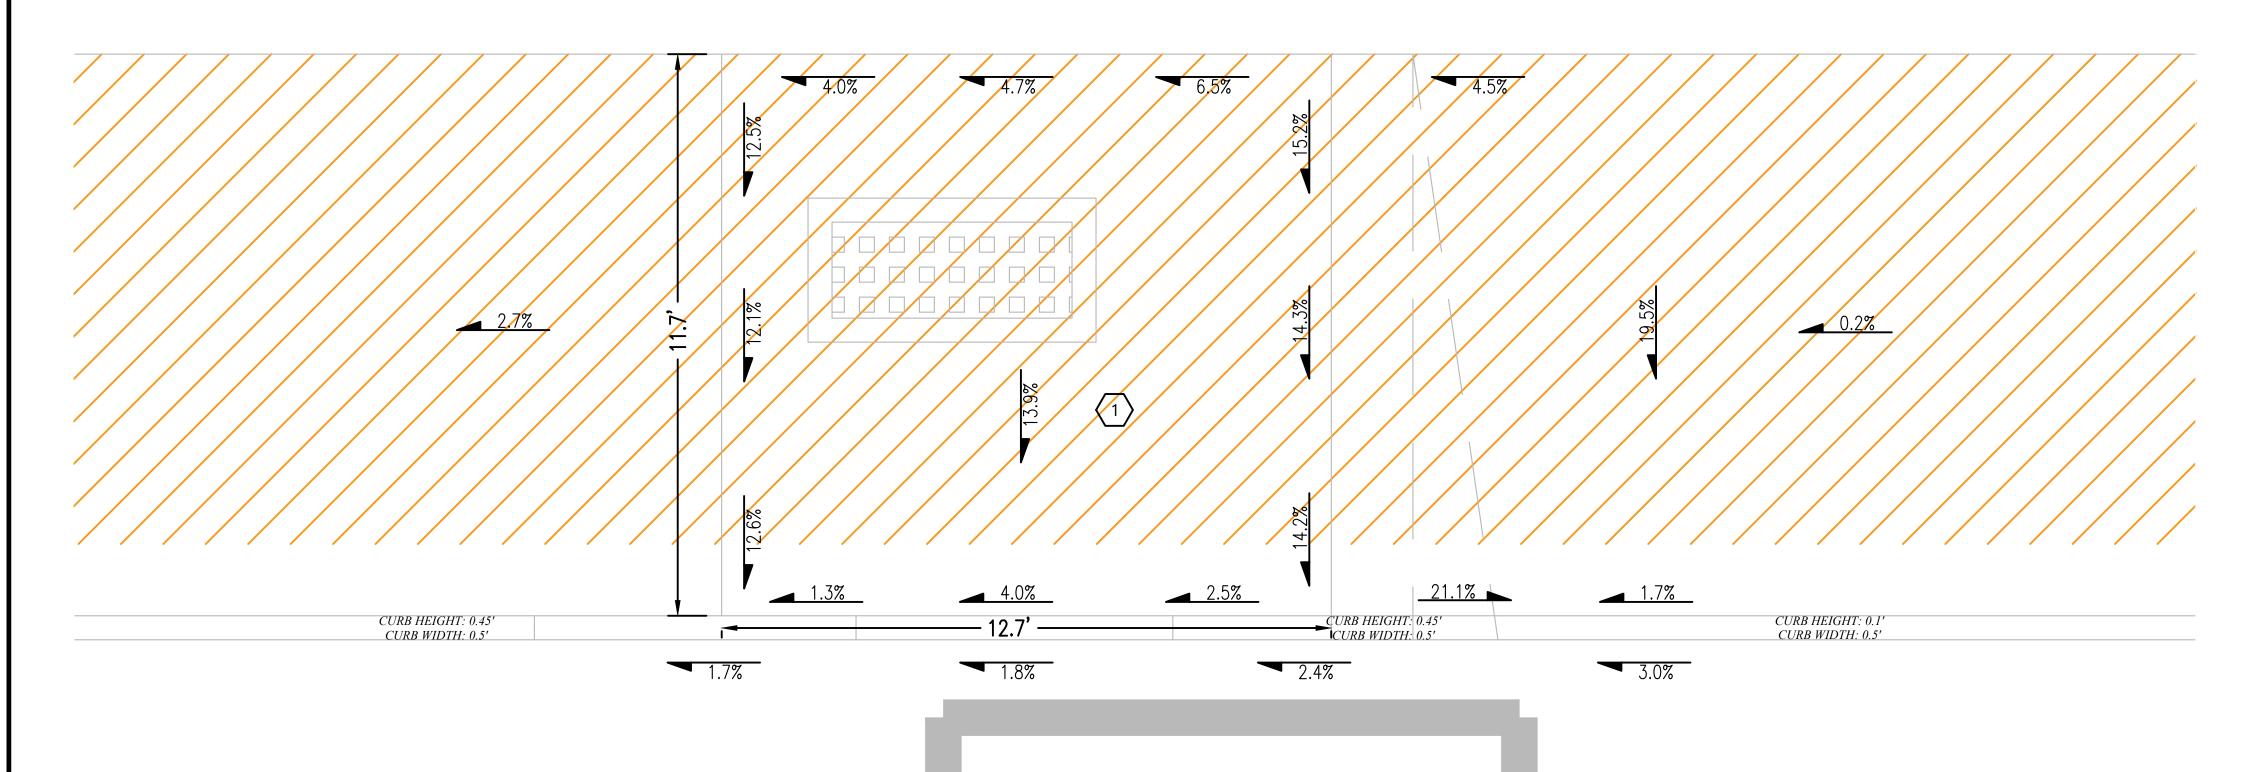


YESLER WAY



PROJECT ENGINEER STAMP

PROJECT BENCHMARK IS ONLY A REFERENCE AND NOT THE ACTUAL ELEVATION



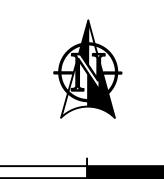

SCALE: NTS

NO.	3/23/20 DATE	MF ENGINEER	DDS DRAFTER	ORIGINAL COMMENT
2	2/17/21	KW	KAW	REVISION # 4
3				AS-BUILT






CLIENT PROJECT MANAGER: GIN VILANTE ENGINEERING FIRM: MGC TECHNICAL CONSULTING INC. PROJECT NUMBER: 15586-023-E PERMIT #:421117 LOCATION: 515 2ND AVE

SEATTLE, WA 98104 DRAWING NAME: MASTEC - 15586-023-E - PLANS.dwg

CONFIDENTIAL/PROPRIETARY SHEET: 25 OF 27



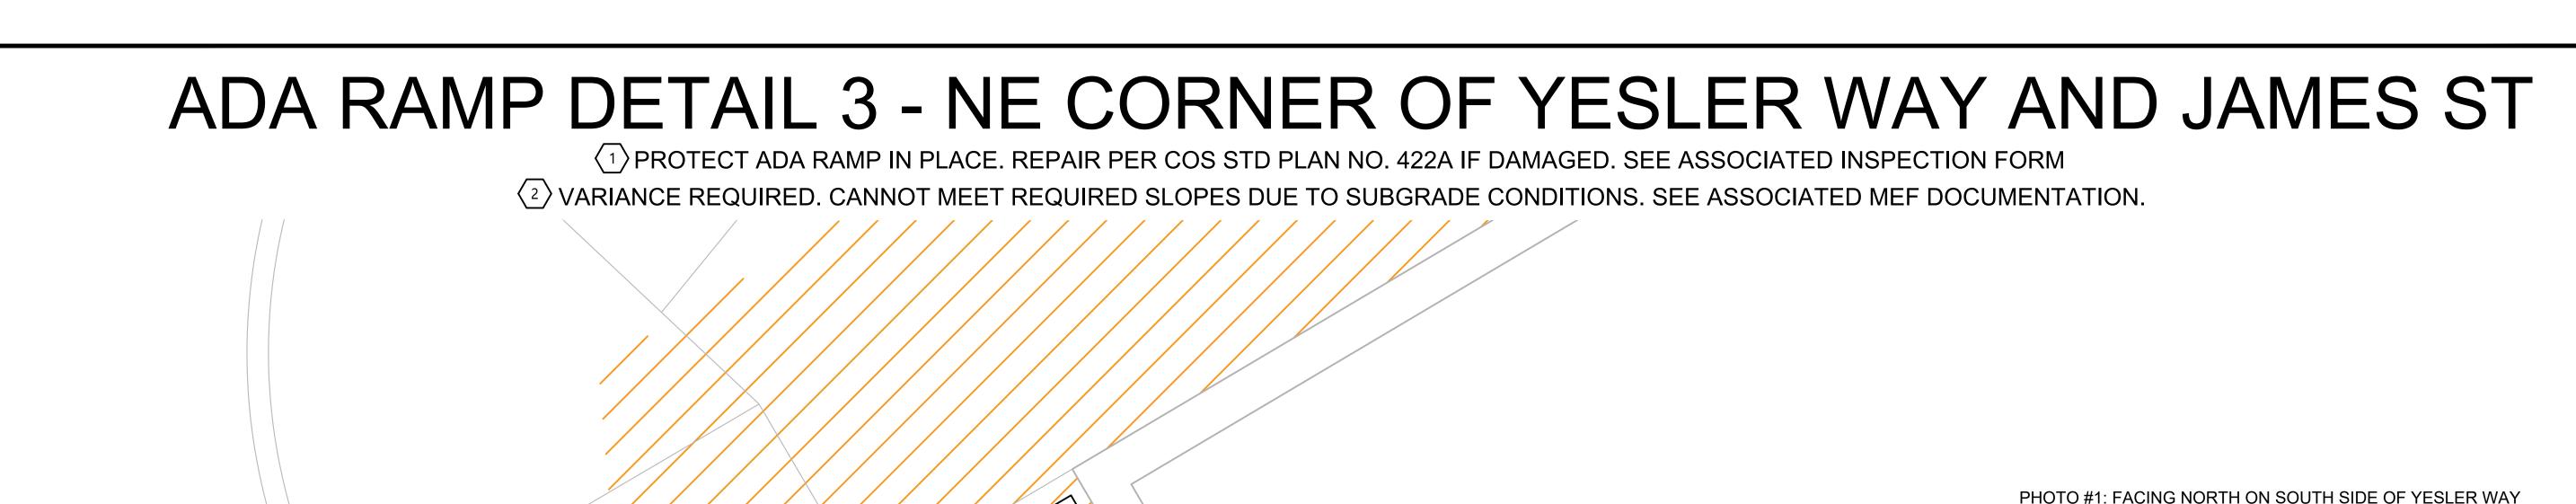

0.4%



PROJECT ENGINEER STAMP

PROJECT BENCHMARK IS ONLY A REFERENCE AND NOT THE ACTUAL ELEVATION



Know what's below.

Call before you dig.

SCALE: NTS

Network Solutions

KW



AS-BUILT REVISION # 4

ORIGINAL

2 2/17/21

3/23/20

CLIENT PROJECT MANAGER: GIN VILANTE **ENGINEERING FIRM: MGC TECHNICAL CONSULTING INC.** PROJECT NUMBER: 15586-023-E PERMIT #:421117

LOCATION: 515 2ND AVE SEATTLE, WA 98104

DRAWING NAME: MASTEC - 15586-023-E - PLANS.dwg CONFIDENTIAL/PROPRIETARY SHEET: 26 OF 27

KAW

YESLER WAY



